


2310 JOHNSON STREET SHREVEPORT, LA 71103

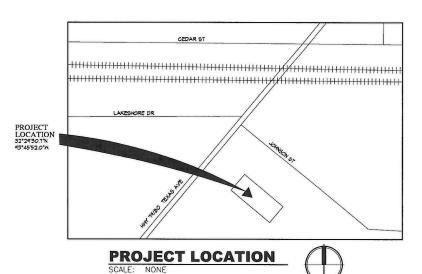



OWNER



1401 WYNKOOP STREET SUITE 500 DENVER, CO 80202 TEL. (720) 495-4600 WWW.ZAYO.COM dave.snyder@zayo.com

PROJECT MANAGER



15925 HARGRAY DRIVE NOBLESVILLE, IN 46062 CONTACT: REX ATKINSON REX@FIVE9DG.COM

MECHANICAL / ELECTRICAL CONSULTING ENGINEERS



9711 VALPARAISO DRIVE MUNSTER, IN 46321 PHONE: (219) 924-8400 WWW.MILLIESENGINEERINGGROUP.COM


CIVIL ENGINEER



1815 SOUTH MEYERS ROAD 630-693-6314 WWW.WOOLPERT.COM

EXECUTIVE DIRECTOR **APPROVAL**


1-27-2021 Date

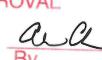


1103 REI 711 SI

2310 JOHNSON SHREVEPORT, I

1-26-21 ISSUED FOR PERMITS

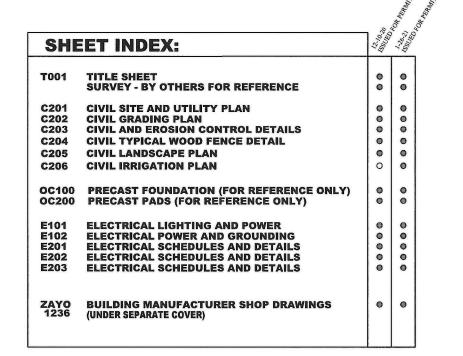

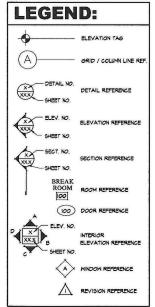


GENERAL INFORMATION: GENERAL NOTES: I. GENERAL CONTRACTOR TO VERIFY ALL ITEMS IN BUILDING UPON DELIVERY, NOTIFY OWNER AND ARCHITECT IMMEDIATELY OF MISSING ITEMS AND COMPONENTS. 2. GENERAL CONTRACTOR TO DO A VISUAL INSPECTION OF THE ROOF UPON DELIVERY AND NOTIFY OWNER AND ARCHITECT OF ANY DEFICIENCIES. ALL LOCATIONS OF EQUIPMENT PENETRATIONS ARE BASED ON BUILDING SUPPLIER SHOP DRAWINGS. **BUILDING NOTES:** . THIS BUILDING IS PRIMARILY USED AS A TELECOMMUNICATIONS ENCLOSURE. 2. BUILDING CAPACITY: 420 SQUARE FEET. **DESIGN CODES:** 2012 INTERNATIONAL BUILDING CODE 2012 NATIONAL ELECTRIC CODE

		CODE REFERENCE
OCCUPANCY	GROUP 52 (TELECOMMUNICATIONS EQUIPMENT BUILDING) BUILDING IS UNOCCUPIED, ACCESSED ONLY BY TRAINED SERVICE PERSONELL AND MONITORED REMOTELY	I.B.G. 304 & NFPA IOI
TYPE OF CONSTRUCTION	VB	I.B.C. 6025
Basic allowable height	MAX 3 STORY, 55'-0" ACTUAL I STORY, II'-1"	I.B.C. TABLE 503
Basic allowable area	23,000 S.F. ALLOW. 420 SF ACTUAL AREA PER BUILDING	I.B.C. TABLE 503
ALLOWABLE AREA INCREASE	NOT REQUIRED	I.B.C. 506
OCCUPANT LOAD	TELECOMMUNICATIONS EQUIPMENT BUILDINGS - 420 SF @ 1/300 - OCCUPANT LOAD = 2	I.B.C. TABLE 1003.2.2.2 8 NFPA 101
EXIT REQUIREMENTS	I REQUIRED , 2 PROVIDED *OCCUPANT LOAD < 50 , TRAVEL DISTANCE > 100'-0"	I.B.C. 1004
FIRE RESISTANCE OF EXTERIOR WALLS FOR TYPE II-B UNPROTECTED (BEARING)	REGMTS ACTUAL 0 0 0 0 0 0 0 0	I.B.C TABLE 601 I.B.C TABLE 602
Exterior Wall openings type II-B (protected)	ALLONED ACTUAL NL N/A NL N/A NL N/A NL N/A	B.C TABLE 704.8
SEISMIC CLASSIFICATION	P	ASCE T-IO
SPECIAL OCCUPANCY REQUIREMENTS	NONE	
FIRE SUPPRESSION SYSTEM	NONE	
ADA COMPLIANCE	N/A, BUILDING IS UNOCCUPIED, LOCKED AND ACCESS IS PERMITTED ONLY BY AUTHORIZED SERVICE PERSONNEL.	ADAAGAFAS

	1-26-21	ISSUED FOR PERMITS REVI
	12-10-20	ISSUED FOR PERMITS
NUMBER	DATE	DESCRIPTION
		ISSUES

TITLE SHEET	
PROJECT NUMBER	1904
CAD FILE:	45T001 DW
DRAWN BY:	RE
CHECKED BY:	851
SHEET NUMBER:	004

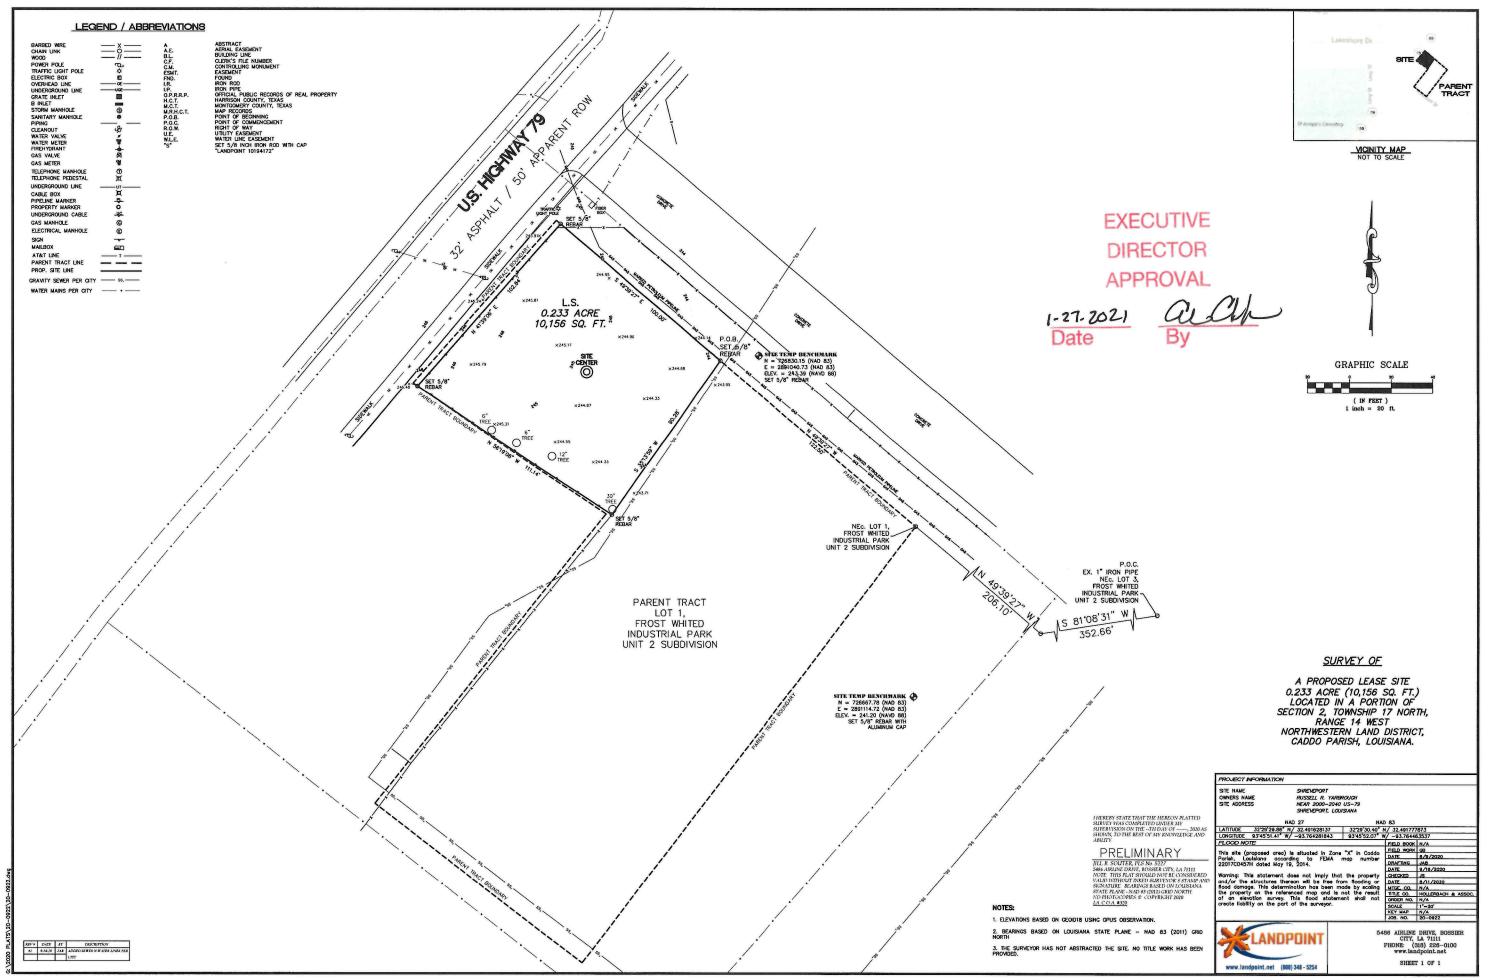

GENERAL NOTES

- 48 HOURS PRIOR TO COMMENCEMENT OF DIGGING, CONTRACTOR SHALL NOTIFY THE FOLLOWING AGENCIES: THE LC PROTECTION SERVICES 811, AND ALL OTHER AGENCIES THAT MAY HAVE UNDERGROUND UTILITIES WITHIN THE PROJ NON-MEMBERS OF I OUISIANA UNDERGROUND PROTECTION SERVICES.
- THE CONTRACTOR AND SUBCONTRACTORS SHALL BE RESPONSIBLE FOR COMPLYING WITH APPLICABLE FEDERAL, STATE AND LOCK REQUIREMENTS, TOGETHER WITH EXERCISING PRECAUTIONS AT ALL TIMES FOR THE PROTECTION OF PERSONS (INCLUDING EMPLICAND PROPERTY. IT IS THE SOLE RESPONSIBILITY OF THE CONTRACTOR AND SUBCONTRACTORS TO INITIATE, MAINTAIN AND SUPER SAFETY REQUIREMENTS, PRECAUTIONS, AND PROGRAMS IN CONNECTION WITH THE WORK.
- . THE CONTRACTOR SHALL INDEMNIFY AND HOLD HARMLESS THE OWNER AND OWNER'S REPRE-DAMAGES TO PERSONNEL, ECUPMENT AND/OR EXISTING FACILITIES OCCURRING IN THE COUR DESCRIBED IN THE PLANS AND SPECIFICATIONS.
- 9. THE CONTRACTOR SHALL COMPLY WITH ALL LOCAL CODES, OBTAIN ALL APPLICABLE PERMITS, AND PAY ALL REQUIRED FEES PRIOR TO COMMERCING WORK.
- 11. ALL WORK PERFORMED BY THE CONTRACTOR SHALL CONFORM TO THE LATEST REGULATIONS OF THE AME
- 12. THE CONTRACTOR SHALL REFER TO OTHER PLANS WITHIN THIS CONSTRUCTION SET FOR OTHER PERTINENT INFORMATION, IT IS NOT THE ENGINEER'S INTENT THAT ANY SINGLE PLAN SHEET IN THIS SET OF DOCUMENTS FULLY DEPICT ALL WORK ASSOCIATED WITH THE PROJECT
- 14. ADJUST OR RECONSTRUCT ALL EXISTING CASTINGS, CLEANOUTS, ETC. WITHIN PROJECT AREA TO MEET PROPOSED GRADE AS REQUIRED
- 15. THE CONTRACTOR SHALL CHECK EXISTING GRADES, DIMENSIONS, AND INVERTS IN THE FIELD AND REPORT ANY DISCREPANCIES TO THE OWNER'S REPRESENTATIVE PRIOR TO BEQUINING WORK
- THE CONTRACTOR SHALL VERIFY THE EXACT LOCATION OF ALL EXISTING UTILITIES. TAKE CARE TO PROTECT UTILITIES THAT ARE TO REMAIN. RELOCATE EXISTING UTILITIES AS INDICATED, OR AS NECESSARY FOR CONSTRUCTION.
- 17. THE CONTRACTOR SHALL ORTAIN ALL REQUIRED PERMITS PRIOR TO COMMENCEMENT OF CONSTRUCTO
- SITE WORK CONCRETE WALKS AND PADS SHALL HAVE A BROOM FINISH TO ALL SURFACES, SITE WORK CONCRETE SHALL BE 4,000 PSI @ 2 DAYS UNLESS OTHERWISE NOTED.
- 20. ALL DAMAGE TO EXISTING PAVEMENT, SIDEWALK, CURB, LANDSCAPING, UTILITIES, AND ANY OTHE THE CONTRACTOR'S OPERATIONS SHALL BE REPLACED WITH LIKE MATERIALS AT THE CONTRACTOR.
- 21. SITE DIMENSIONS SHOWN ARE TO THE FACE OF CURB, BUILDING, WALL, EDGE OF PAVEMENT, OR COLUMN LINE UNLESS OTHERWISE NOTED

UTILITY NOTES

- LANDSCAPE AREA TO BE 100% IRRIGATED BY AN UNDE DESIGN IS TO BE PROVIDED BY CONTRACTOR.


- I. THE CONTRACTOR SHALL OBTAIN ALL REQUIRED PERMITS PRIOR TO COMMENCEMENT OF CONSTRUCTION

- ADJUST ALL EXISTING UTILITY SURFACE FEATURES INCLUDING BUT NOT LIMITED TO CASTINGS, VALVE BOXES, PEDESTALS, CLEANOUTS, ETC, TO MATCH PROPOSED FINISHED GRADES, UNLESS OTHERWISE INDICATED.
- MECHANICAL/ELECTRICAL CONTRACTORS SHALL BRING ALL UTILITIES 5' OUTSIDE BUILDING WALL, COORDINATE WITH CON
- 14. ALL WATER SERVICE PIPE, 2" AND SMALLER, SHALL BE K SOFT COPPER.
- WATERLINE IS TO BE BEDDED WITH CLEAN GRANULAR MATERIAL AGGREGATES ABOVE THE PIPE

APPROVAL:

METROPOLITAN PLANNING COMMISSION (MPC)

DATE

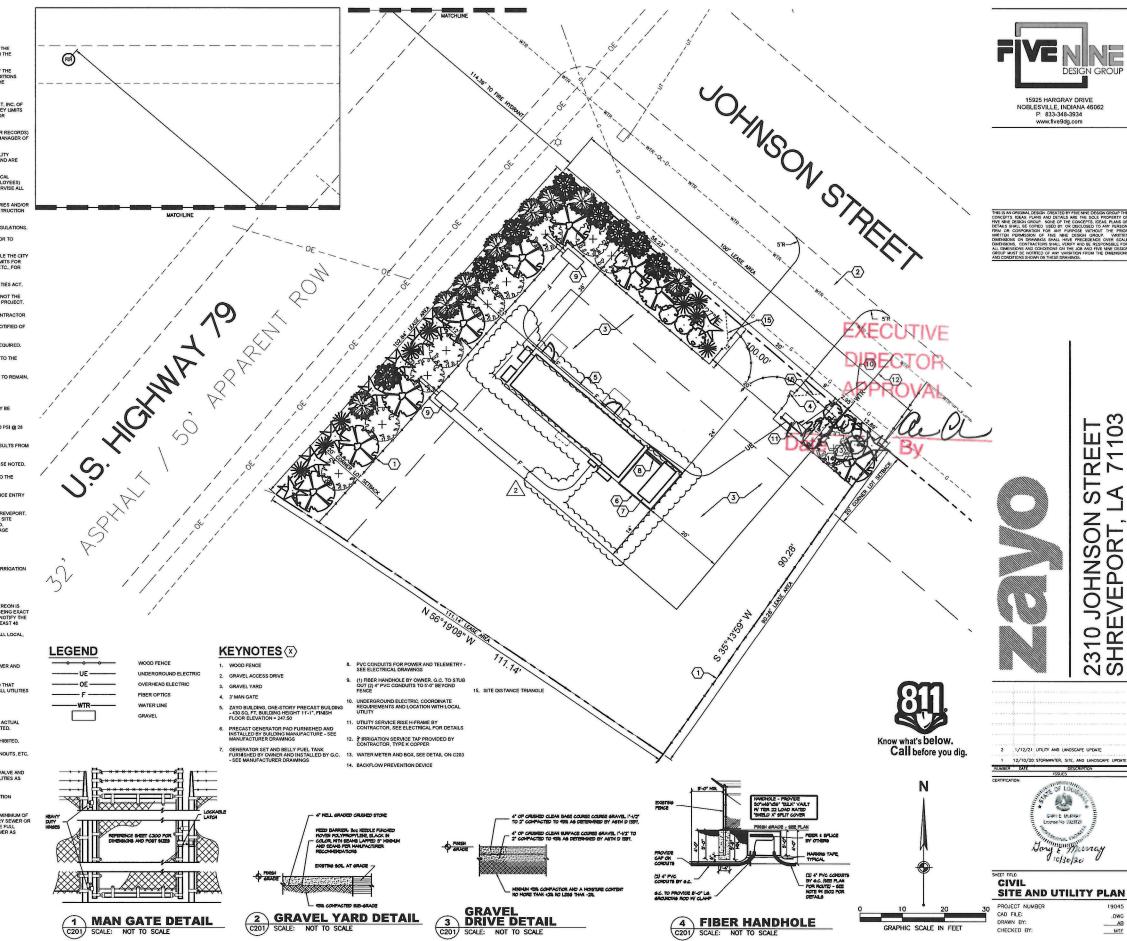

20-179-C

C201

12/10/20 STORMWATER, SITE, AND LANDSCAPE

GARTE MURRAY License No. 0323726

Jany E 1) way


NOBLESVILLE, INDIANA 46062 P: 833-348-3934 www.five9dg.com


N STREET LA 71103

2310 JOHNSON SHREVEPORT, I

SITE EARTHWORK NOTES

STORM DRAINAGE NOTES

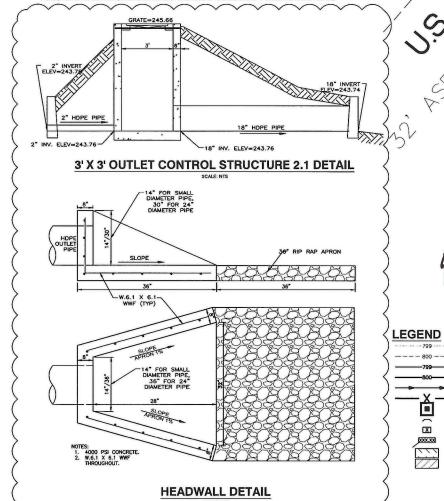

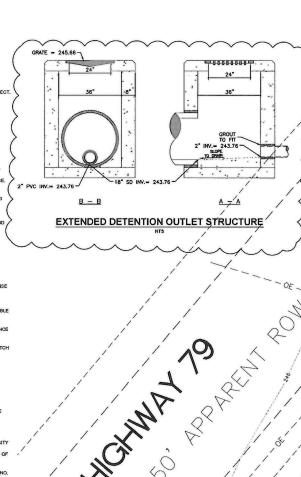

5. OUTLET CONTROL STRUCTURE

(<u>B</u>


SILT FENCE

STORM STRUCTURE ID

FROSION CONTROL BLANKE

SPOT ELEVATION

EXECUTIVE **DIRECTOR APPROVAL** KEYNOTES (X)

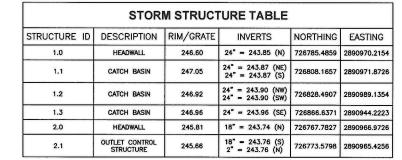



2310 JOHNSON STREET SHREVEPORT, LA 71103

GARYE MURRAY License No. 1013720 Jany 10/30/20


SHEET TITLE: **GRADING PLAN**

PROJECT NUMBER CAD FILE: DRAWN BY: CHECKED BY.

Know what's below. Call before you dig.

DATE

METROPOLITAN PLANNING COMMISSION (MPC)

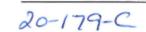


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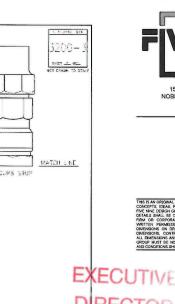
DIRECTOR **APPROVAL**


1-27-2021 Date

CITY OF SHREVEPORT TYPICAL WATER METER

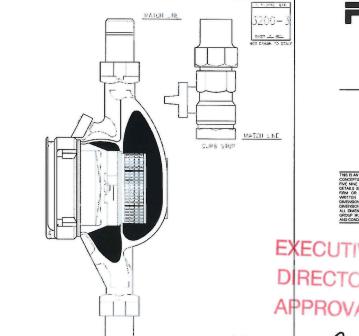

THIGHY OF SHREVEPORT STANDARD SPECIF



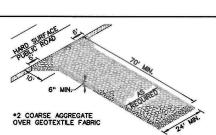

STANDARD PLAN

601-9

APPROVED. REW

2-0

MUMBER OF OPENINGS (0 TO 4) AS DIRECTED BY PROJECT ENGINEER

4'-0" MIN

REINF. IN BOX #4 BARS # 8" O.C., EACH WAY

SECTION "B - B"

R.C. CATCH BASIN SHALL CONFORM TO A.A.S.H.O. DESIGNATION M-85 CLASS A CONCRETE (3800 P.S.I. - 28 DAYS) PORTLAND CEMENT.

CITY OF SHREVEPORT

GRATE INLET TYPE B (OFF ROADWAY USE ONLY)

USE WITH CITY OF SHREVEPORT STANDARD SPECIFICATIONS

NOTES :

Sel o Berney

DES)

1, ALL CORNERS TO BE CHAMFERED 3/4".

2. RUBBED FINISH REQUIRED ON EXPOSED SURFACES.

4. 24' ROUND CJ. FRAME AND LID BITUMINOUS COATED.

6. STEEL MESH TO CONFORM TO A.S.T.M. A-185.

8. BACKFILL TO BE COMPACTED TO 95% DENSITY.

7. GRATES TO BE CENTERED.

REINFORCE BARS SHALL CONFORM TO A.S.T.M. DESIGNATION A-615 (GRADE 40).


TEMPORARY CONSTRUCTION ACCESS


STABILIZATION TYPE:	JAN	FEB.	MAR	APR	MAY	JUN.	JUL	AUG.	SEP.	ост.	NOV.	DEC
PERMANENT SEEDING			A-			•	•		-			
DORMANT SEEDING	-		7									
TEMPORARY SEEDING			c-			•	D		_			
SODDING			Eoo -									
MULCHING	-											

- A = PROVIDE SW DURA TURF MIX AVAILABLE FROM
 B = TRUPOINTE COOPERATIVE, INC., PIQUIA, OHIO
 PLUS 2 TON/AC, STRAW MULCH
 C = SPRING OATS © 100 LBS/AC.
 D = WHEAT OR CERCEL, RIVE © 150 LBS/AC
 E = SOO
 WILLCH © 150 LBS/AC
 E = ST
- REF. = SCS "RAINWATER AND LAND DEVELOPMENT"

NOTE: INTERIM SEEDING TO BE UTILIZED FOR AREAS TO BE LEFT UNDISTURBED AS STATED ON NOTE \$5 OF THE "EROSION CONTROL REQUIREMENTS FOR COMPULANCE WITH KDEP'S GENERAL PERMIT FOR CONSTRUCTION."

TYPICAL SOIL PROTECTION CHART

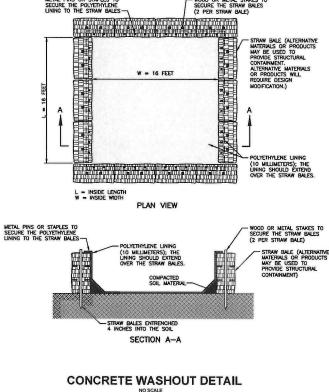


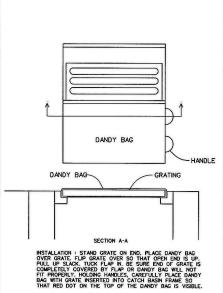

CITY OF SHREVEPORT

TYPICAL WATER METER

WITH CITY OF THREVERORT STANDARD SEEDFICAT

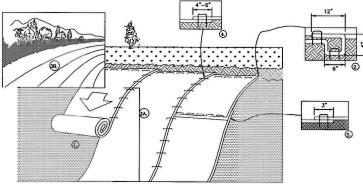

3200-

ATCH LINE

- 1. PREPARE SOIL BEFORE INSTALLING BLANKETS, INCLUDING ANY NECESSARY APPLICATION OF LIME, FERTILIZER, AND SEED.
- 2. BEGIN AT THE TOP OF THE SLOPE BY ANCHORING THE BLANKET IN A 6" DEEP X 6" MDE TRENCH WITH A ROW OF BLANKET EXTRADED BEYOND THE UP-SLOPE PORTION OF THE TRENCH. ANCHOR THE BLANKET WITH A ROW OF STAPLES/STAKES APPROXIMATELY 12" ART IN THE BOTTOM OF THE TRENCH. BACKETLL AND COMPACT THE TRENCH AFTER STAPLING. APPLY SEED TO COMPACTED SOIL AND FOLD REMAINING 12" PORTION OF BLANKET BACK OVER SEED AND COMPACTED SOIL SCOURE BLANKET OVER COMPACTED SOIL WITH A ROW OF STAPLES/STAKES SPACED APPROXIMATELY 12" APART ACROSS THE WIDTH OF THE BLANKET.
- THE EDGES OF PARALLEL BLANKETS MUST BE STAPLED WITH MINIMUM 6° OVERLAP. TO ENSURE PROPER SEAM ALIGNM PLACE THE EDGE OF THE OVERLAPPING BLANKET (BLANKET BEING INSTALLED ON TOP) EVEN WITH THE SEAM STITCH ON PREVIOUSLY INSTALLED BLANKET.
- CONSECUTIVE BLANKETS SPUCED DOWN THE SLOPE MUST BE PLACED END OVER END (SHINGLE STYLE) WITH AN
 APPROXIMATE 3" OVERLAP. STAPLE THROUGH OVERLAPPED AREA, APPROXIMATELY 12" APART ACROSS ENTIRE BLANKET WIDTH. 6. PLACE STAPLES/STAKES PER MANUFACTURE RECOMMENDATION FOR THE APPROPRIATE SLOPE BEING APPLIED.
- IN LOOSE SOIL CONDITIONS, THE USE OF STAPLE OR STAKE LENGTHS GREATER THAN 6" MAY BE NECESSARY TO PROPERLY SECURE THE BLANKETS.

EROSION CONTROL BLANKET (SLOPE INSTALLATION)






12/10/20 STORMWATER, SITE, AND LANDSCAPE UPDATE GARY E MURRAY Literae No. 1023726

SHEET ITILE:
CIVIL AND EROSION CONTROL DETAILS

PROJECT NUMBER CAD FILE: DRAWN BY: CHECKED BY:

DWG _____BB ____TTM

20-179-C

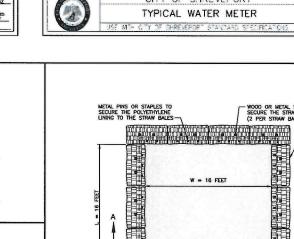

- 11

3200-

SER SHEET BOY AND 3 FOR METER DETAIL

PERTAIN TO SERVICE LINES 3/4 INCH TO 2 INCHES N DAMETER

OF WEW

WATER WESTER

FRONT ELEVATION

CITY OF SHREVEPORT


TYPICAL WATER METER

SEL LUVATION

MAINTENANCE: AFTER SILT HAS DRIED, REMOVE IT FROM THE SURFACE OF DANDY BAG WITH BROOM.

DANDY BAG




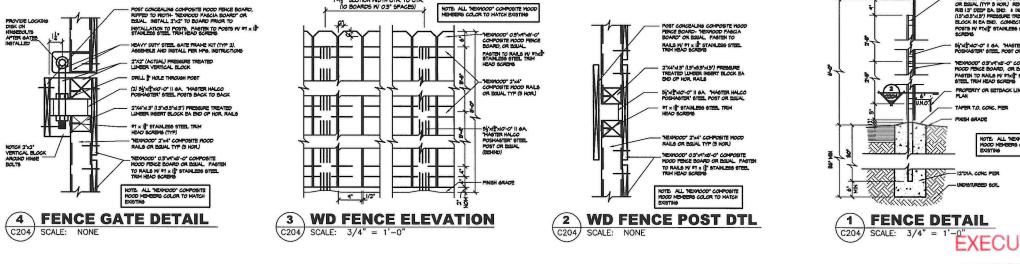

PASTER TO RAILS W STATE STAINLESS STEEL TRIM HEAD SCREWS

DATE

EXECUTIVE DIRECTOR APPROVAL

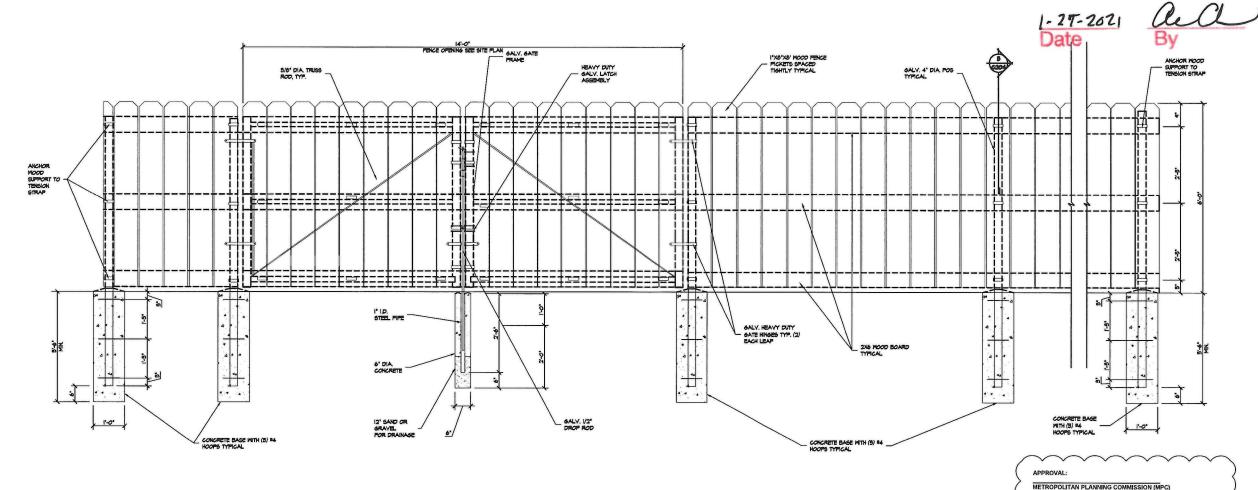

1 12/10/20 STORWWATER, SITE, AND LANDSCAPE UPDAT



SHEET TILE:
CIVIL TYPICAL WOOD
FENCE DETAIL

PROJECT NUMBER CAD FILE: DRAWN BY: CHECKED BY:

19045 .DWG ____AB ___MTF

N STREET LA 71103

2310 JOHNSON SHREVEPORT, I

C204


1 FENCE DETAIL C204 SCALE: 3/4" = 1'-0'

20-179-C

		PLANT S	CHEDULE			1	
SYMBOL	BOTANICAL NAME	COMMON NAME	MATURE WIDTH/HEIGHT	SIZE	-	REMARKS	
(+)	WEIGELA	WEIGELA FLORIDA	8'-0" W X 8'-0" T	2 GALLON	10	SEE OTL (408)	
公	FORSYTHIA FORSYTHIA X INTERMEDIA		6°-0° W X 8'-0° T	r	9	SEE DIL GIOS	
3	CAMELLIA			3 GALLON	8	SEE OTL GOOD	
-	DRIFT ROSE SERIES			1 GALLON	8	SEE OTL (1	
8	BANANA SHRUB			3 GALLON	9		
0	JAPANESE FLOWERING QUINCE	CHAENOMELES JAPONICA	3'-0" W X 4'-0" T	1 GALLON	9	SEE DIT.	
*	GARDENIA	GARDENIA JASMINODES	4'-0" W X 4'-0" T	2 GALLON	9	SEE DTL (SIGN	
PLANTIN 1. LIN 2. TOO ARR TRE 3. EXC BE BE TIM 4. TRE TIM 5. ALL SYS REA 7. ALL APP 8. COI 9. PRO 10. 00	JTIES, PIPES, STRUCTURES SOOL REMOVED DURING CC. AS. NO MATERIAL OR TEVE IT THUNK. SEPT WHILE ENCAGED IN TRUDING BUT NOT LIMITED I OPERATED WITHIN SIX (8) E IN SUCH A MANNER AS ESS SHALL BE HANDLED BY INTERPRET SHALL BE SHALL RECE CONTINIER FROWN MET SIDES (NOVED, BUT NOT SHALL HOP PLANT VARIETIES MUST CHARACTER'S OPTION TO US VIDEN RECESSARY HUMBUS STOLE TO THE STANDER SHOULD BE SHOULD BE SHOULD BE STOLE THE SHOULD BE STANDER SHOULD BE SHOULD BE STANDER SHO	INSTRUCTION SHALL BE STOMEOFORMY SOIL DEPOSITS SHE IEEE REMOVAL, NO MECHANICO D BULLDOZERS, EARTH MOV FEET OF ANY PROTECTED TO TO BREAK, TEAR, BRUISE, O' ROOT BALLS ONLY. DO NO TALLED PLUMB. WE A 3" TOP DRESS LAYER RIAL MUST BE OF NURSERY OF THE CONTAINER SO AS WE EXCESSIVE ROOT GROWTH DIME FROM A SAME SOURCE E READILY AVAILABLE SIMILA NUD STARTER FERTILIZERS TO EIN GOOD CONDITION, RE- PE IN GOOD CONDITION, RE-	CKPILED ON-SITE AND REAL BE PLACED WITHIN SI AL EQUIPMENT WEIGHING FERS, OR OTHER HEAVY FOR OTHER HEAVY FOR OTHER HEAVY FOR OTHERWISE INJURE AN TO DAMAGE BALL, TRUNK, OF SHREDDED HARDWOOL STOCK CONDITIONS WITH TO MANITAIN A FIRM BALL H ENCIRCLING THE INSIDE SUPPLIER IN ORDER TO R MALERIAL AT LAWN ARE O ALL AREAS AS REQUIRE	USED IN OF X (6) FEET IN EXCESS ONSTRUCTION TO SHALL BE Y LIVING OR OR LOOSEN D MULCH. A WHEN THE COMMAINTAIN A AS.	OF AND OF TWO OF	LANDSCAPE (EXISTING ((2) TONS, MENT, SHALL SHED AT ANY INT TREE. I FROM BALL ED ROOT INER IS R. ITENT	
NUE	RSERY LABELS UNTIL END	RECT AFTER PLANTING, STAN OF MAINTENANCE PERIOD. M. REES, OWNER ZAYO TO REP	AINTENANCE PERIOD IS TO	BE 60 DA	YS MINI	MUM WITH A	

SHRUB PLANTING DETAIL

(2205) SCALE: NOT TO SCALE

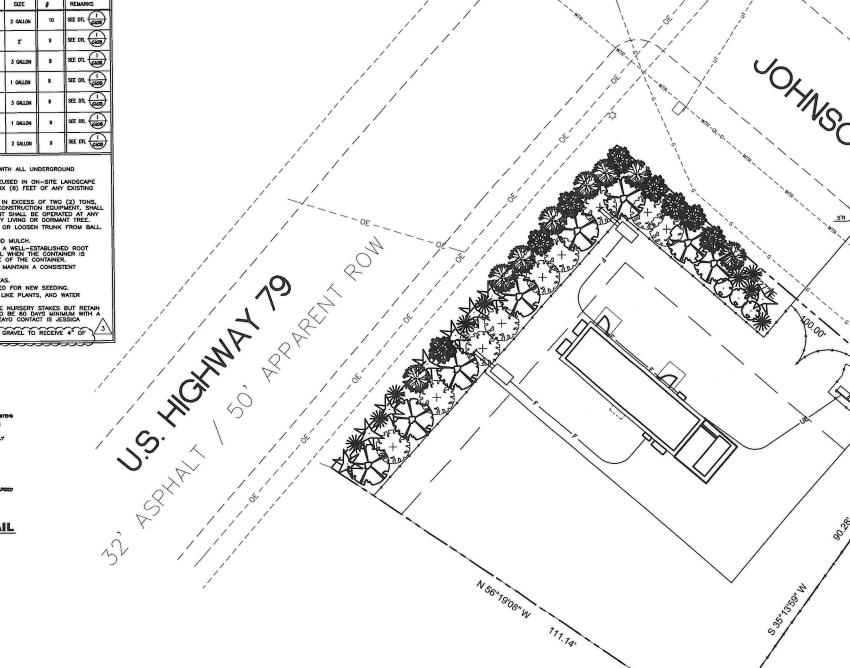


2310 JOHNSON STREET SHREVEPORT, LA 71103

15925 HARGRAY DRIVE NOBLESVILLE, INDIANA 46062 P: 833-348-3934 www.five9dg.com

SHEET TITLE:
CIVIL
LANDSCAPE PLAN

C205

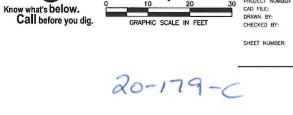



1-27-2021 Date

IRRIGATION NOTES


9. IRRIGATION CONTRACTOR SHALL ALL PROVIDE THE FIRST WINTERIZATION, SPRING TURN ON, HEAD ADJUSTANTINANCE IN RID.


IRRIGATION LEGEND


SYMBOL

89	HUNTER ICZ-101-25-LF 1" DRIP VALVE
	AREA TO RECEIVE DRIPLINE HUNTER HDL-06-12-PC
SYMBOL	MANUFACTURER/MODEL
53	HUNTER HQ-5LRC 1" QUICK COUPLER
(BF)	ZURN 975XL 1" BACKFLOW
C	HUNTER PHC CONTROLLER WITH HYDROWISE
R	HUNTER WRF-CLIK RAIN SENSOR
POC	POINT OF CONNECTION 1"
	IRRIGATION LATERAL LINE: PVC CLASS 200 SDR 21 1"
	IRRIGATION MAINLINE: PVC CLASS 200 SDR 21 1"
	PIPE SLEEVE: PVC SCHEDULE 40 4"


MANUFACTURER/MODEL

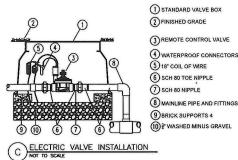

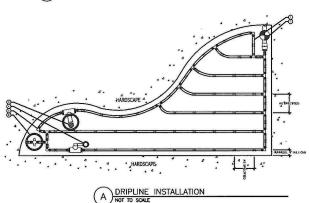

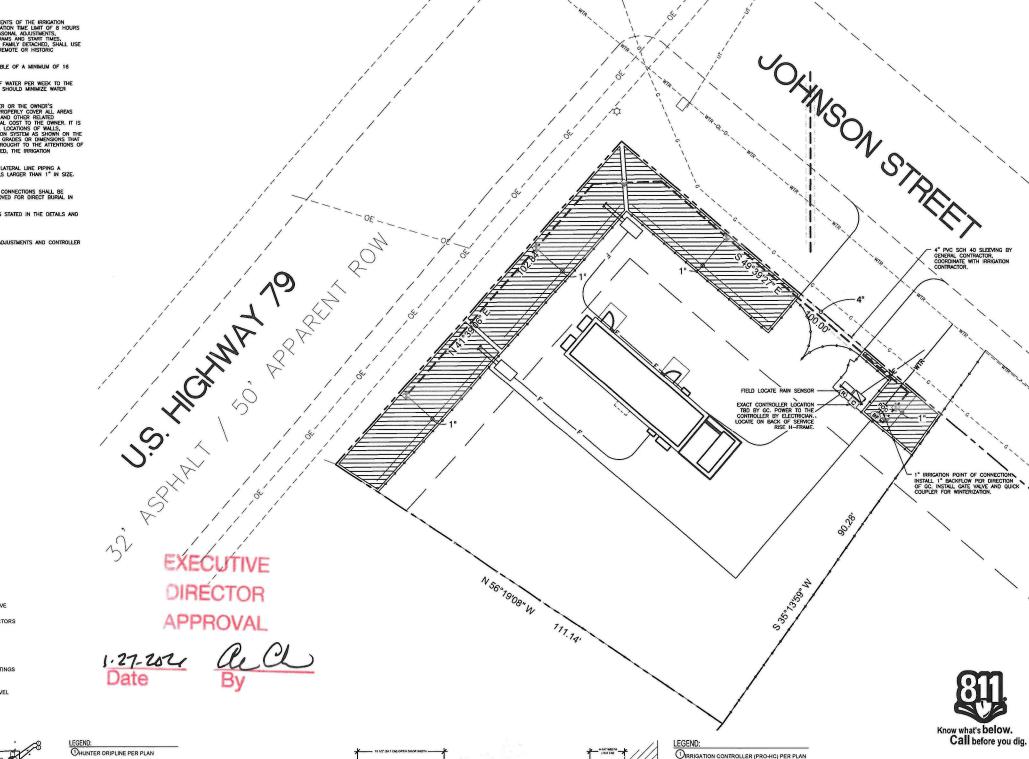



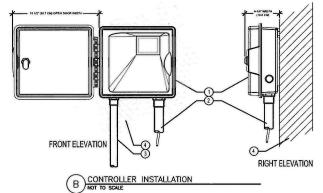

DIRRIGATION CONTROLLER (PRO-HC) PER PLAN ② IRRIGATION CONTROL WIRE IN CONDUI 3 ELECTRICAL SUPPLY CONDUIT CONNECT TO POWER SOURCE, J-BOX INSIDE CONTROLLER ADJACENT SURFACE TO MOUNT CONTROLLER PER PLAN

NOTE
MOUNT CONTROLLER LCD SCREEN AT EYE
LEVEL, CONTROLLER SHALL BE HARD-MRED TO
APOLINDED 110 VAC POWER SOURCE



NOBLESVILLE, INDIANA 46062 P: 833-348-3934 www.five9dg.com

1/12/21 UTILITY AND LANDSCAPE UPDATE


IRRIGATION PLAN

PROJECT NUMBER CAD FILE: DRAWN BY: CHECKED BY:

.DWG ____AB ___NTF **C206**

20-179-0

GRAPHIC SCALE IN FEET

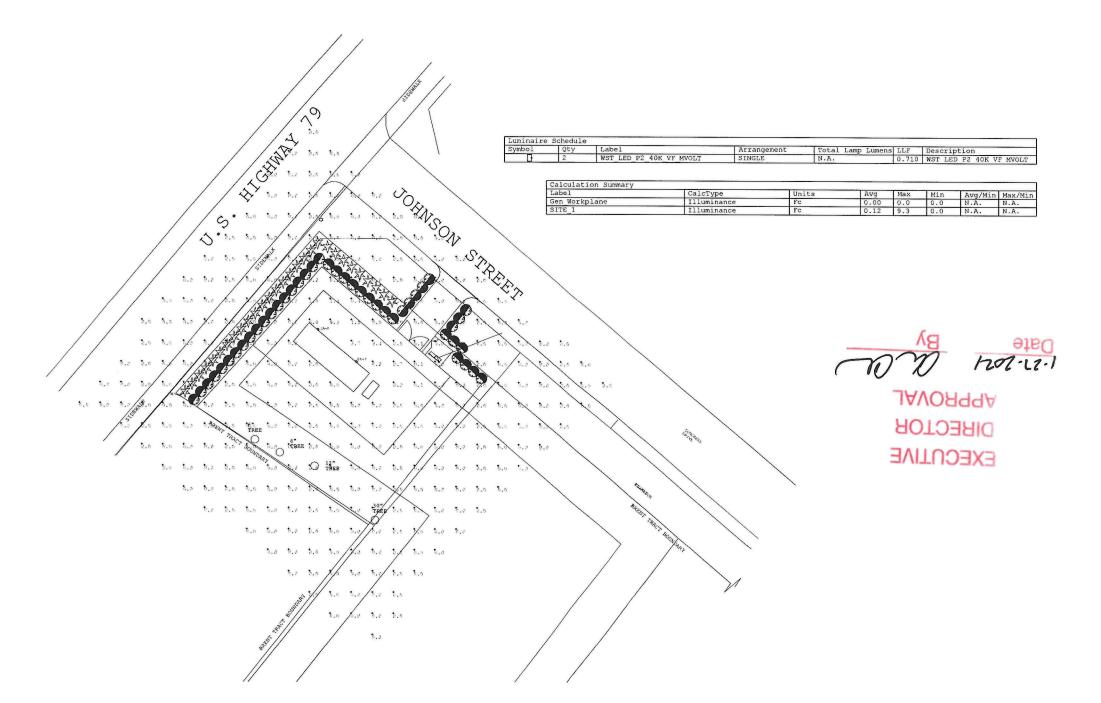





UNASSIGNED JOHNSON STREET SHREVEPORT, LA 71103



	10/1/20	ISSUED FOR PERMIT
	8/28/20	ISSUED FOR 100% REVIEW
MOER		DESCRIPTION ISSUES
TIFICA	NON MANUAL	OF LOWING

SHET TILE ELECTRICAL SITE PLAN

PROJECT NUMBER CAD FILE: DRAWN BY: CHECKED BY:

19045 E1-1.DWG BK MS

E001 20-179-C

SITE PHOTOMETRIC PLAN

SCALE: 1" = 20'-0"

TOTAL WEIGHT OF THE BUILDING: 95,300 lbs (ESTIMATED)
WEIGHT OF THE BUILDING WITHOUT EQUIPMENT: 86,800 lbs (ESTIMATED)
MAXIMUM LOAD AT LIFTING LUG: XX,XXX lbs
SHIPPING WEIGHT OF BUILDING: 95,300 lbs (ESTIMATED)
BUILDING MUST BE LIFTED USING ALL LIFTING POINTS

SINGLE BUILDING SET UP PROCEDURE:

- INSPECT BUILDING UPON DELIVERY FOR DAMAGE DURING TRANSPORTATION.
- 2. REMOVE LIFTING BRACKETS FROM SHELTER.
- 3. CAULK AND GROUT BUILDING.
- 4. ATTACH TIE DOWN BRACKETS (SHIPPED LOOSE INSIDE SHELTER) TO SHELTER AND FOUNDATION USING ANCHOR BOLTS.
- INSTALL AND CAULK ALL ACCESSORIES(EXTERIOR LIGHT, CANOPY, ICE SHEILD, VENT HOODS, GROUND BARS, ETC.)
- 6. INSPECT ROOF AND ROOF EDGE FOR DAMAGECAUSED BY OFFLOAD AND REPAIR IF NEEDED.
- 7. CLEAN INTERIOR AND COMPLETE ANY TOUCH UP PAINTING AS NEEDED.
- 8. CHECK DOOR ALARM (IF APPLICABLE) FOR PROPER OPERATION.
- 9. CHECK LIGHTING AND AIR CONDITIONING FOR PROPER OPERATION.
- 10. INSPECT COMPLETE BUILDING FOR COSMETICS & FUNCTION.

OFFLOAD NOTES:


- 1. BUILDING SHALL BE OFFLOADED IN LEVEL
- 2. ALL CABLES, SHACKLING, SPREADER BARS, ETC. SHALL BE DESIGNED AND SUPPLIED BY OWNER'S CONTRACTOR.
- ALL LIFTING POINTS SHALL BE USED.
- 1 5/8" MAXIMUM DIAMETER FOR SHACKLE PIN.
- 5. OFFLOAD SKID WITH CABLES IN VERTICAL POSITION.
 a. FLOOR LIFT: STRAIGHT PICK RECOMMENDED ANGLEDPOSITION
 CABLES MORE THAN 30° ALONG WALL AND 5° FROM WALL (FROM
 VERTICAL AXIS) ARE NOT ACCEPTABLE.
- 6. LIFTING BRACKETS WILL BE REMOVED FOR TRANSPORT.
 LIFTING BRACKETS WILL NEED TO BE REINSTALLED AT SITE BY
 OTHERS AND ALL MOUNTING HARDWARE TORQUED TO 140 ft-lbs
 PRIOR TO LIFTING.


FIBREBOND NOT RESPONSIBLE FOR RIGGING


THESE ILLUSTRATIONS ARE FOR REFERENCE ONLY.
ALL RIGGING EQUIPMENT AND POINTS OF CONNECTION ARE
THE RESPONSIBILITY OF THE RIGGER.


ALL WEIGHTS ARE ESTIMATED

RECOMMENDED THAT THE SPREADER BAR BE 2ft WIDER THAN THE COMPONENT BEING LIFTED AND MINIMUM 4ft ABOVE.

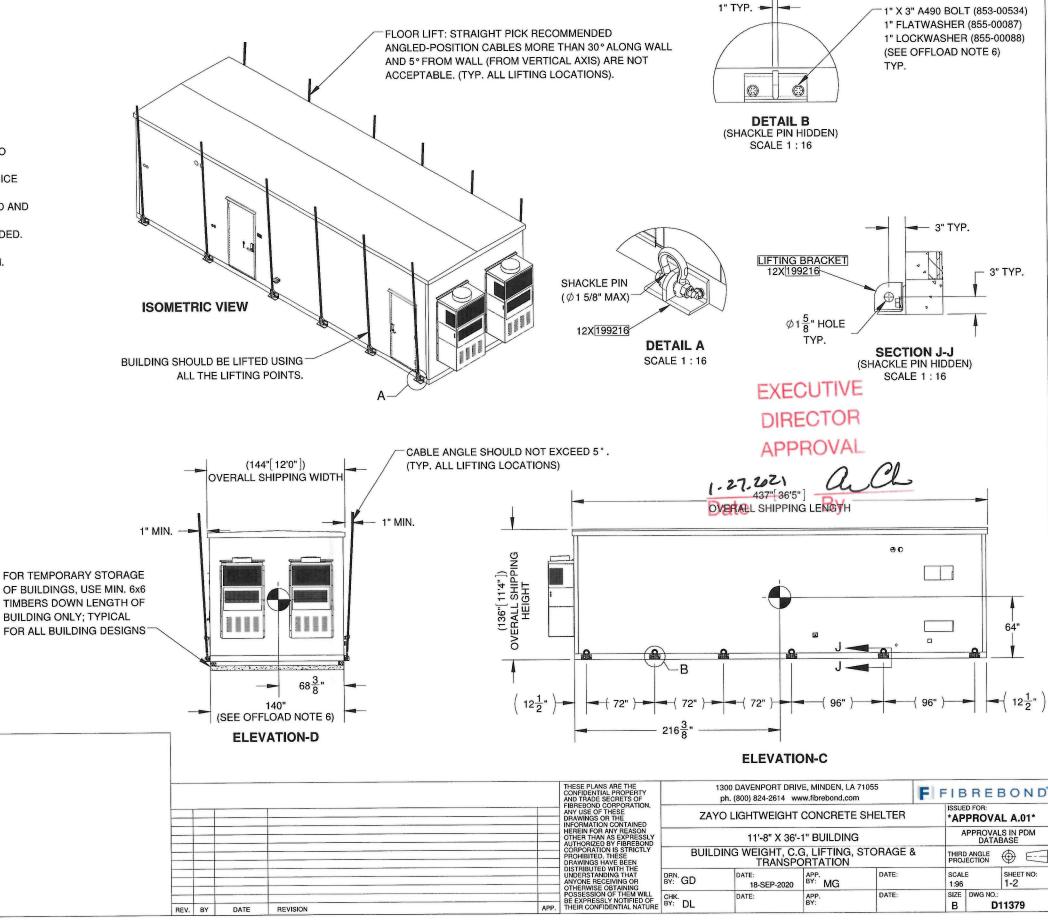

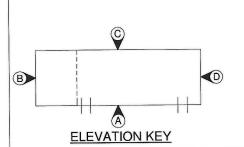

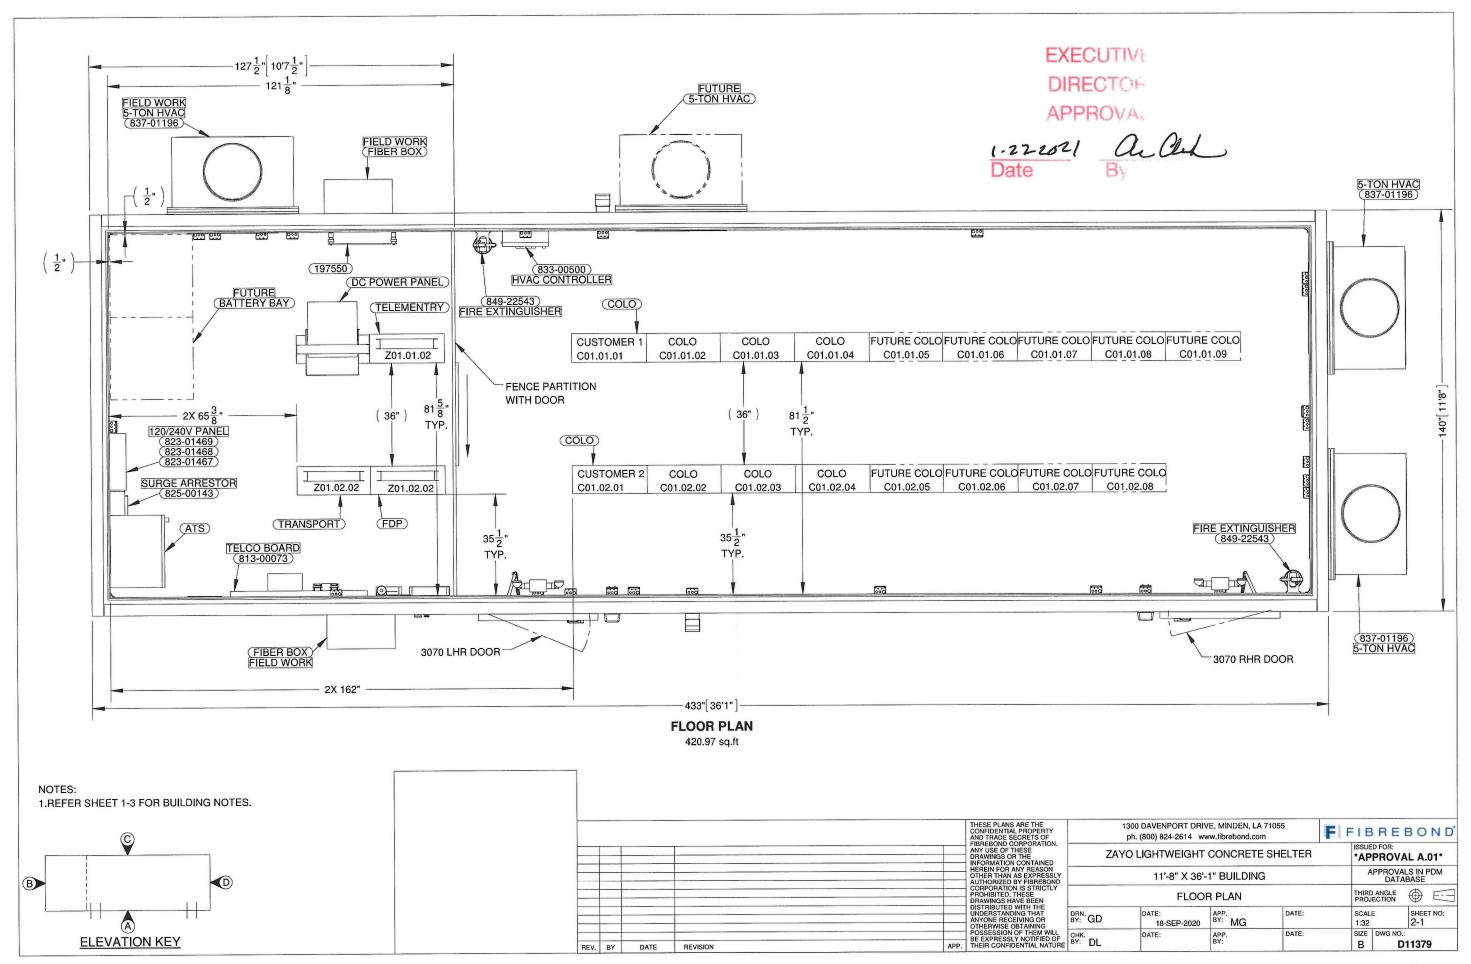

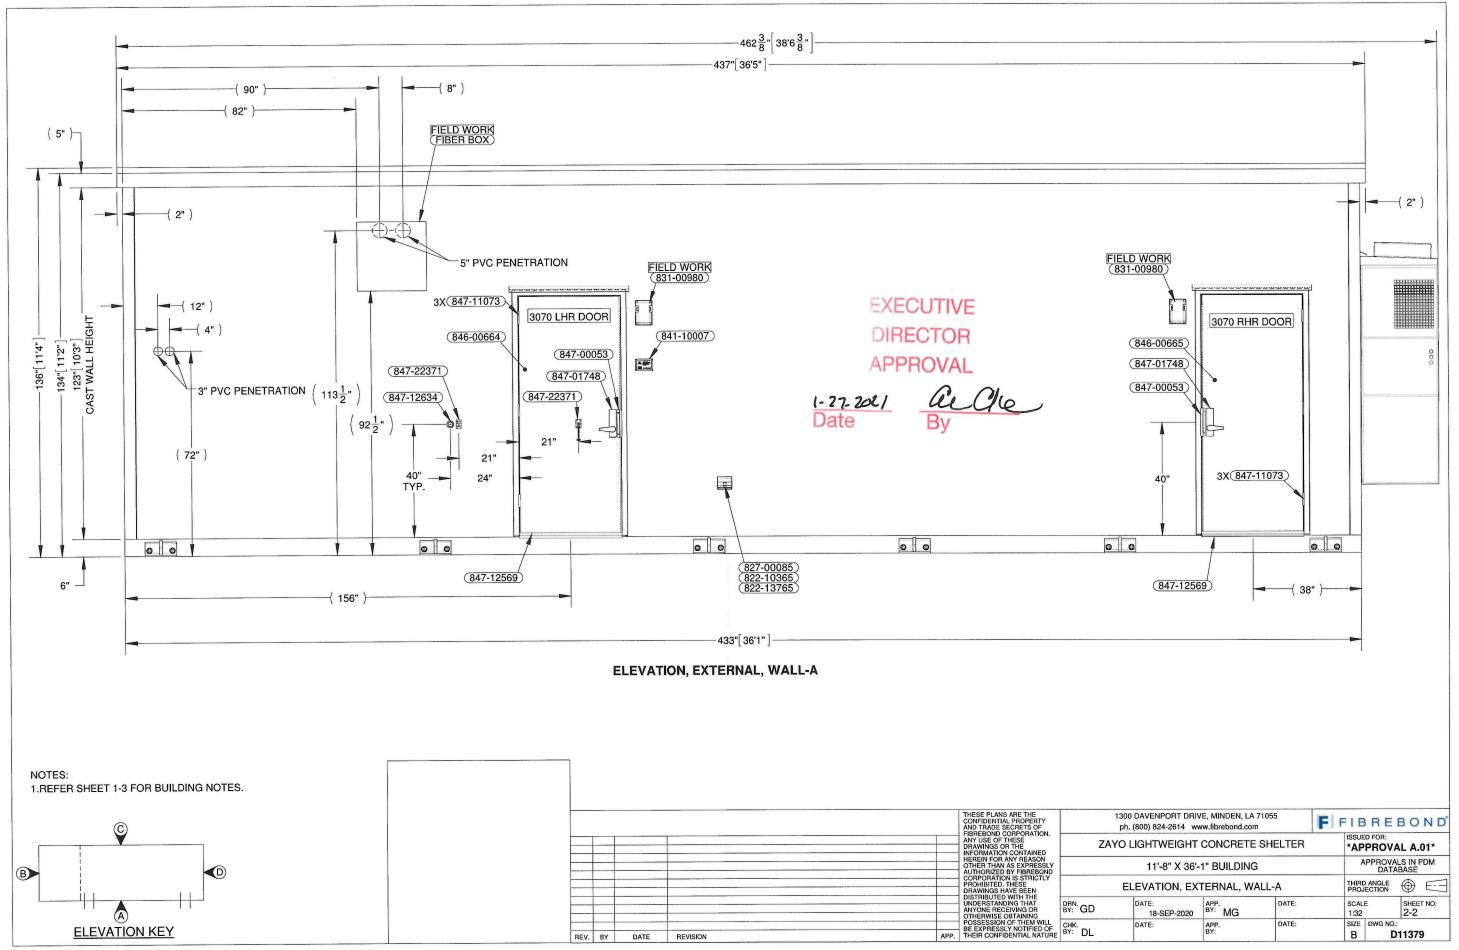

20-179-C

