



VICINITY MAP



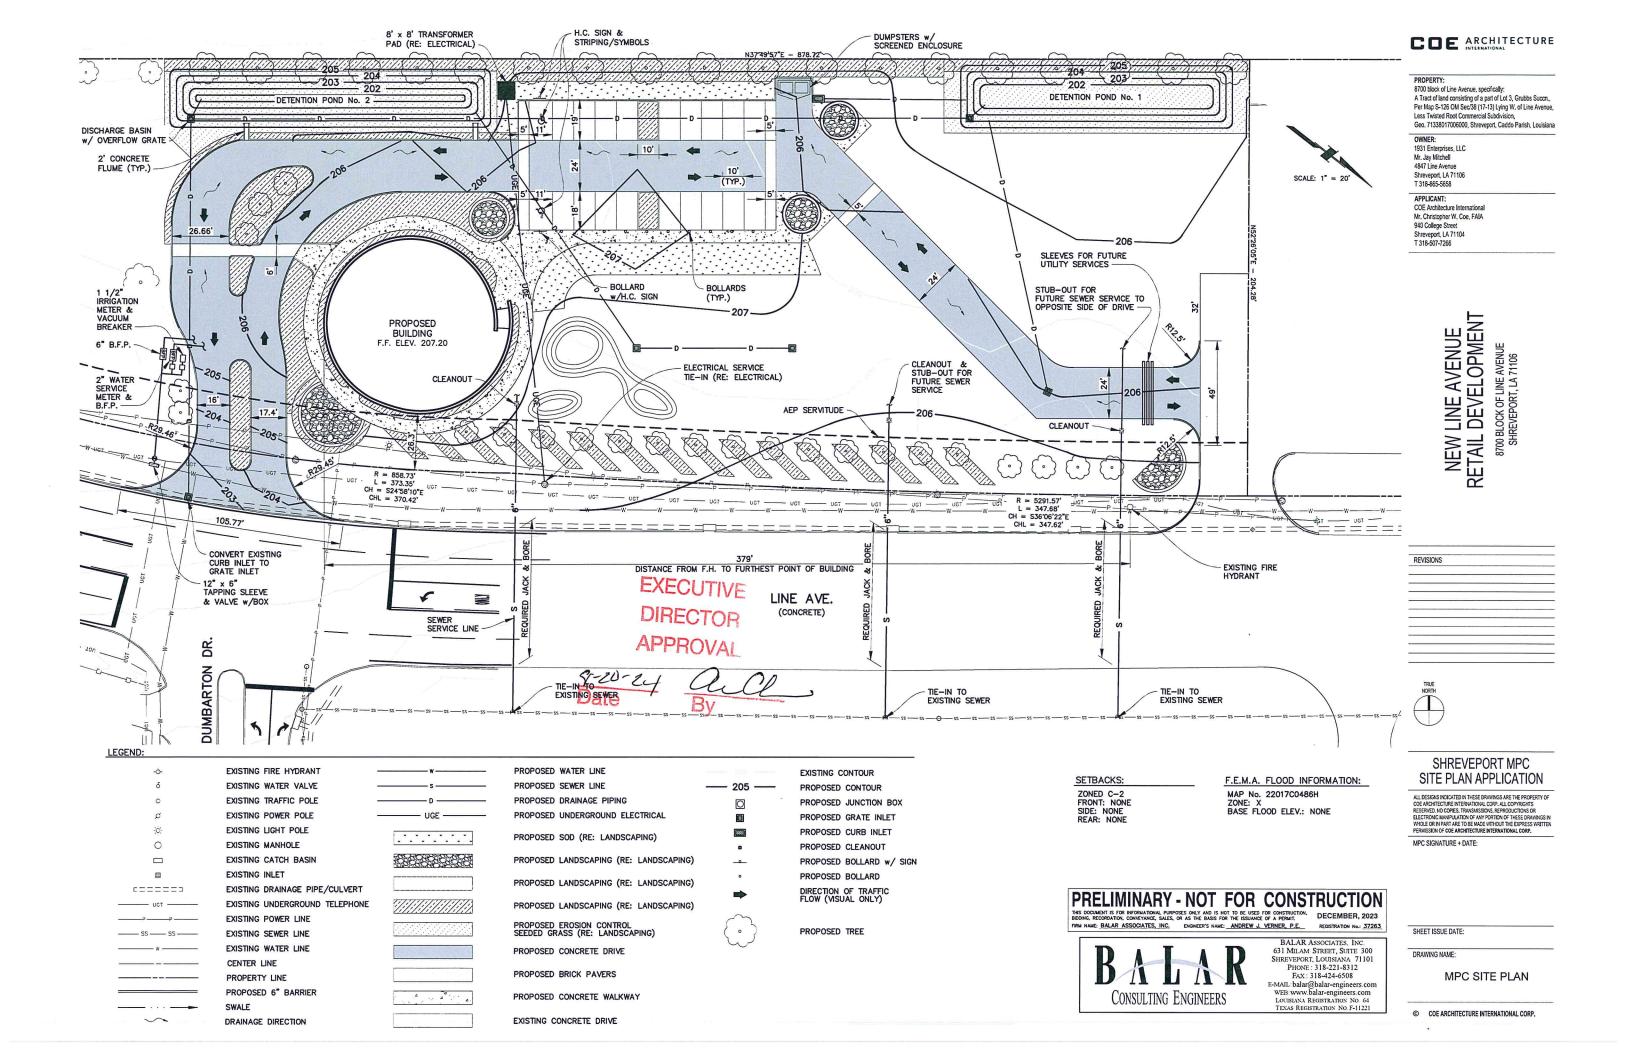

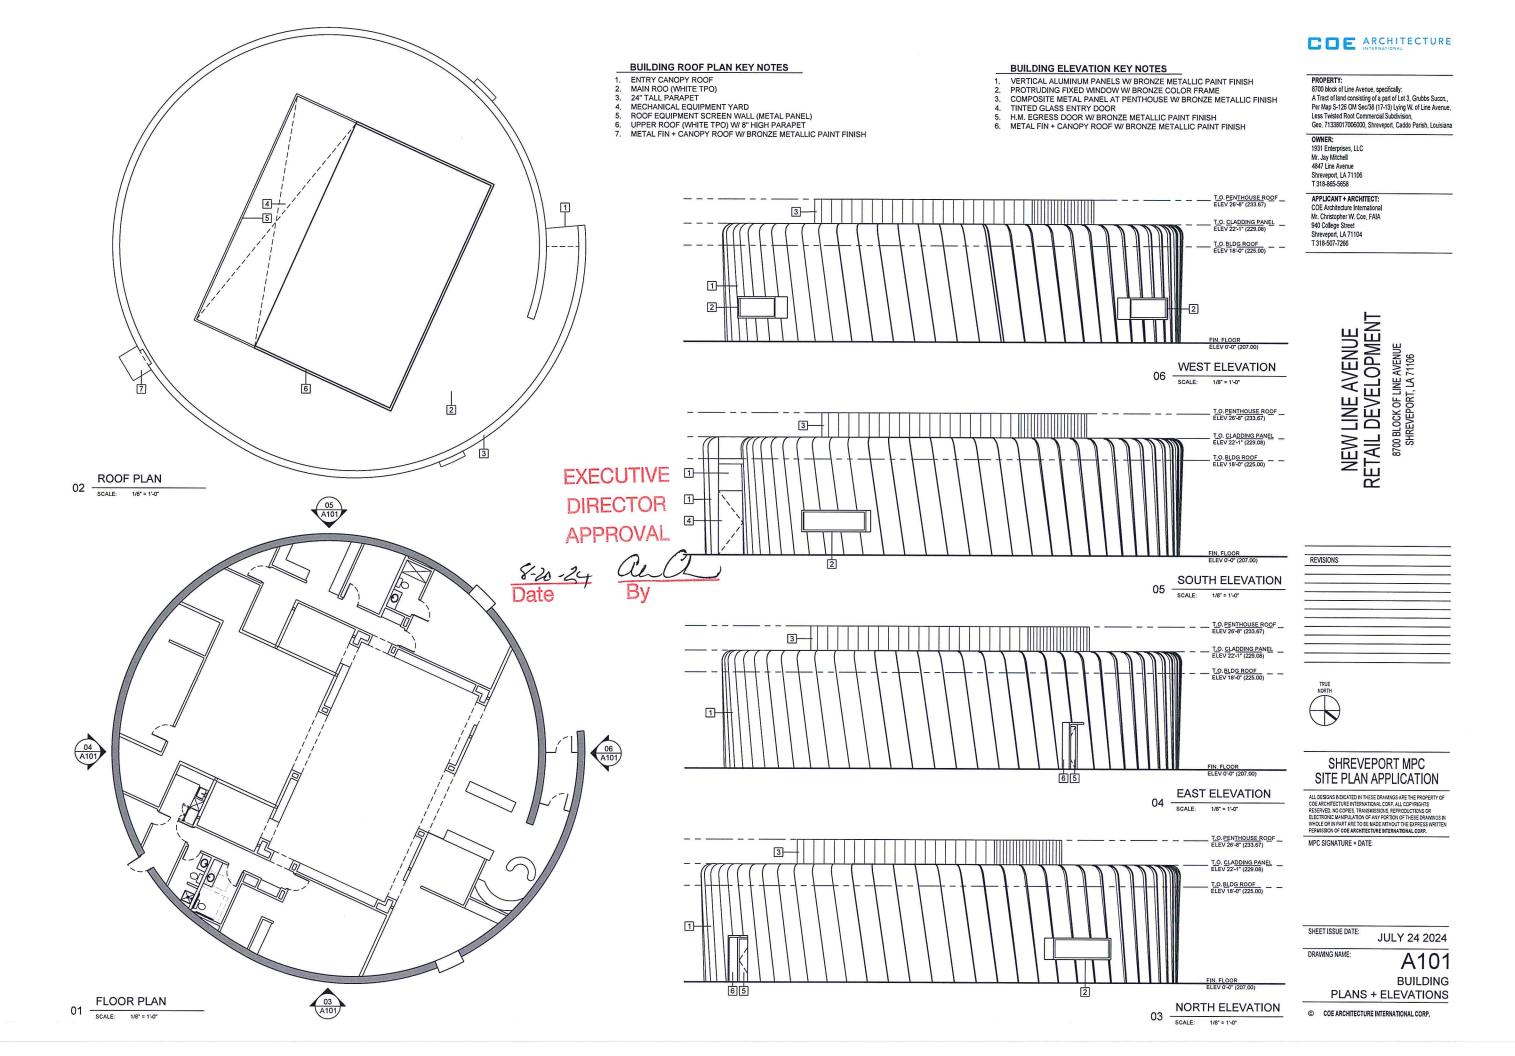

EXECUTIVE DIRECTOR **APPROVAL**



PROPERTY:
8700 block of Line Avenue, specifically:
A Tract of land consisting of a part of Lot 3, Grubbs Succn.,
Per Map S-126 OM Sec/38 (17-13) Lying W. of Line Avenue,
Less Tiwisted Root Commercial Subdivision,
Geo. 71338017006000, Shreveport, Caddo Parish, Louisiana

OWNER: 1931 Enterprises, LLC Mr. Jay Mitchell 4847 Line Avenue Shreveport, LA 71106 T 318-865-5658

APPLICANT + ARCHITECT: COE Architecture International Mr. Christopher W. Coe, FAIA 940 College Street Shreveport, LA 71104 T 318-507-7266

NEW LINE AVENUE
RETAIL DEVELOPMENT
8700 BLOCK OF LINE AVENUE
SHREVEPORT, LA 71106



SHREVEPORT MPC SITE PLAN APPLICATION

ALL DESIGNS INDICATED IN THESE DRAWINGS ARE THE PROPERTY OF COCK ACCHITECTURE INTERNATIONAL CORP ALL CONTRIGHTS RESERVED. NO CORES TRANSMISSIONS REPRODUCTIONS OF ELECTRONIC UNAPPLIATION OF ANY PORTION OF THESE DRAWINGS IN WHOLE OR IN ART ARE TO SEE MADE WHOLT THE DIPPESS WRITTEN PERMISSION OF COE ARCHITECTURE INTERNATIONAL CORP.

MPC SIGNATURE + DATE:

SHEET ISSUE DATE:

BUILDING RENDERING

01 SCALE: NO SCALE

JULY 24 2024

DRAWING NAME:

A102

BUILDING RENDERING



EXECUTIVE DIRECTOR

S-2024 Audle By



PROPERTY:
8700 block of Line Avenue, specifically:
A Tract of land consisting of a part of Lot 3, Grubbs Succn.,
Per Map S-126 OM Sec/38 (17-13) Lying W. of Line Avenue;
Less Tiwisted Root Commercial Subdivision,
Geo. 71338017006000, Shreveport, Caddo Parish, Louisiana

OWNER: 1931 Enterprises, LLC Mr. Jay Mitchell 4847 Line Avenue Shreveport, LA 71106 T 318-865-5658

APPLICANT + ARCHITECT: COE Architecture International Mr. Christopher W. Coe, FAIA 940 College Street Shreveport, LA 71104 T 318-507-7266

NEW LINE AVENUE
RETAIL DEVELOPMENT
8700 BLOCK OF LINE AVENUE
SHREVEPORT, LA 71106

REVISIONS



SHREVEPORT MPC SITE PLAN APPLICATION

ALL DESIGNS NOICATED IN THESE DRAWINGS ARE THE PROPERTY OF COC ARCHITECTURE INTERNATIONAL CORP. ALL COPPRIGHTS RESERVED, IN CORPS. TRANSMISSIONS ERPRODUCTIONS OR ELECTRONIC MAINFULATION OF ANY PORTION OF THESE DRAWINGS IN WHOLE OR IN PART ARE TO BE MADE WITHOUT THE EXPRESS WRITTEN FERNISSION OF TOE ARCHITECTURE INTERNATIONAL CORP.

MPC SIGNATURE + DATE:


SHEET ISSUE DATE:

JULY 24 2024

DRAWING NAME:

A103

BUILDING RENDERING

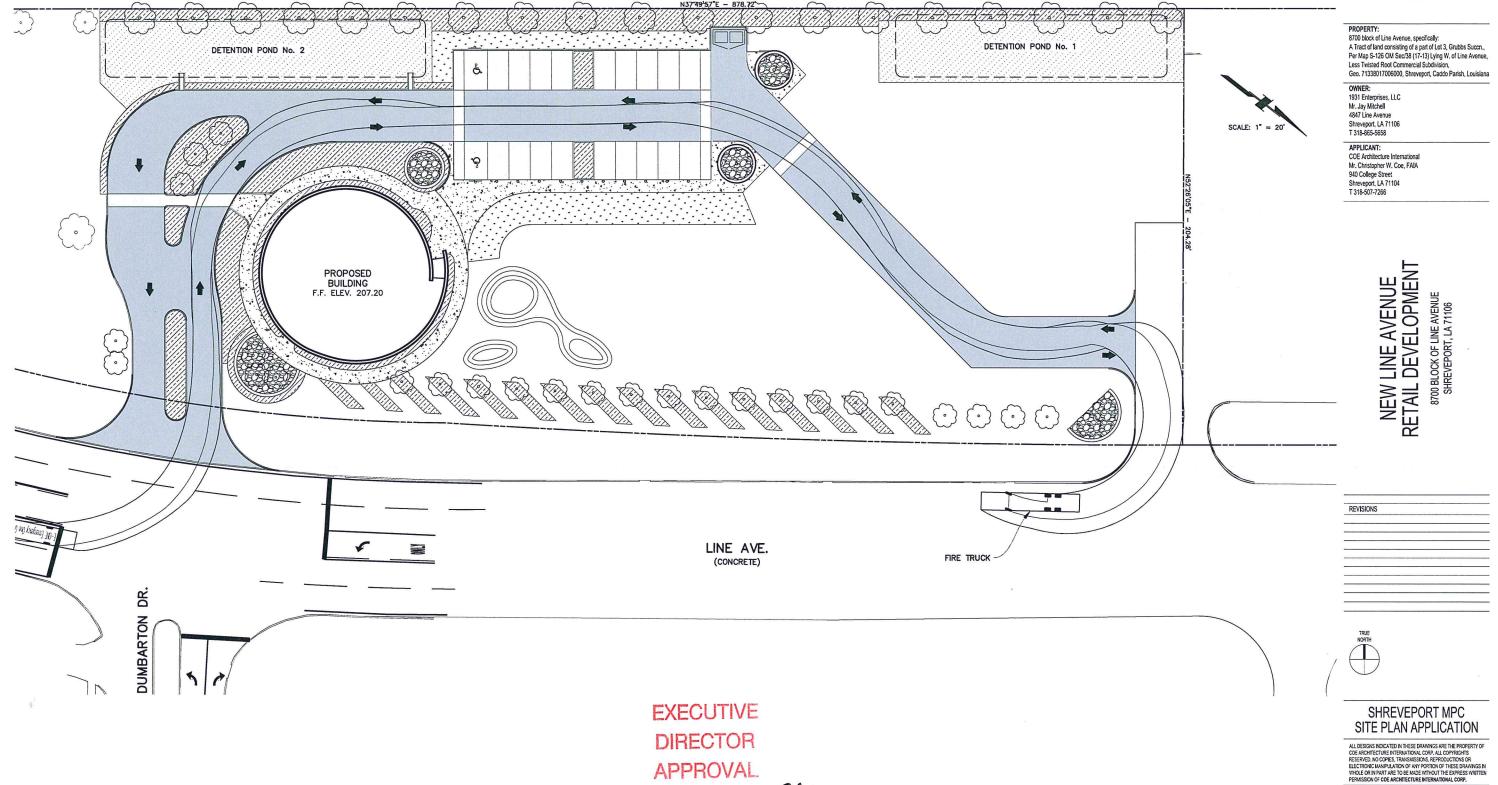

PRELIMINARY - NOT FOR CONSTRUCTION

THIS DOCUMENT IS FOR INFORMATIONAL PURPOSES ONLY AND IS NOT TO BE USED FOR CONSTIDUTION,
BEDDONG, RECORDATION, CONVEYENCE, SALES, OR AS THE BASS FOR THE SISSUANCE OF A PERBUTI.

FIRM MANE: BALAR ASSOCIATES, INC.

DISCRETE SHAME: ANDREW J. VERNER, P.E.

REGISTRATION No.: 37263


BALAR
CONSULTING ENGINEERS

BALAR ASSOCIATES, INC.
631 MILAM STREET, SUTTE 300
SHEEVEPORT, LOUISIANA 71101
PHONE: 318-221-8312
FAX: 318-424-6508
E-MALL balar@balar-engineers.com
WEB: www.balar-engineers.com
LOUISIANA REGISTRATION NO 64
TEXAS REGISTRATION NO 5-11221

SHEET ISSUE DATE:

MPC SIGNATURE + DATE:

MPC VEHICLE TRACKING PLAN 1 OF 3

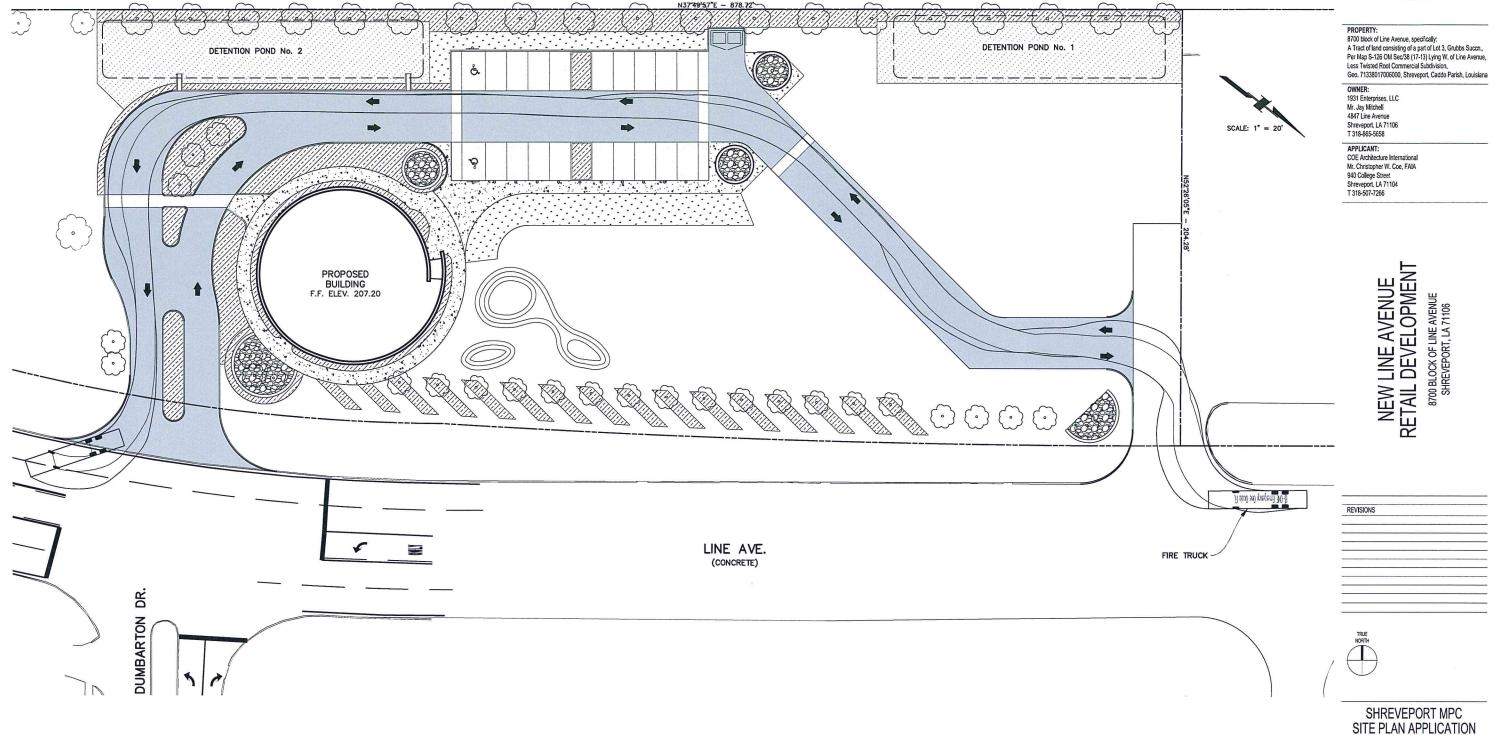

EXECUTIVE DIRECTOR APPROVAL

7-20-24 Q. Q.

PRELIMINARY - NOT FOR CONSTRUCTION

THES DOCUMENT IS FOR REFORMATIONAL PURPOSES ONLY AND IS HOT TO BE USED FOR CONSTRUCTION.
BOOMER, RECORDATION, CONCEYNING, SALES, OR AS THE BASS FOR THE ESSUANCE OF A PERMIT.
FIRM HAME: BALAR ASSOCIATES, INC. DIGNER'S NAME: ANDREW J. VERNER, P.E. REGISTRATION No.: 37263




BALAR ASSOCIATES, INC.
631 MILAM STREET, SUITE 300
SHREVEPORT, LOUISIANA 71101
PHONE: 318-221-8312
FAX: 318-424-6508
E-MAIL-balar@balar-engineers.com
WEB.www.balar-engineers.com
LOUISIANA REGISTRATION NO. 64
TEXAS REGISTRATION NO. F-11221

SHEET ISSUE DATE:

MPC SIGNATURE + DATE:

DRAWING NAME: MPC VEHICLE TRACKING PLAN 2 OF 3

ALL DESIGNS INDICATED IN THESE DRAWINGS ARE THE PROPERTY OF COE ARCHITECTURE INTERNATIONAL CORP. ALL COPPRIGHTS RESERVED. NO COPPS. TRANSINSSIONS, REPRODUCTIONS OR ELECTRONIC LIMATULATION OF ANY PORTION OF THESE DRAWINGS IN WHOLE OR IN PART ARE TO BE MADE WITHOUT THE EXPRESS MITTEN PERMISSION OF COE ARCHITECTURE INTERNATIONAL CORP.

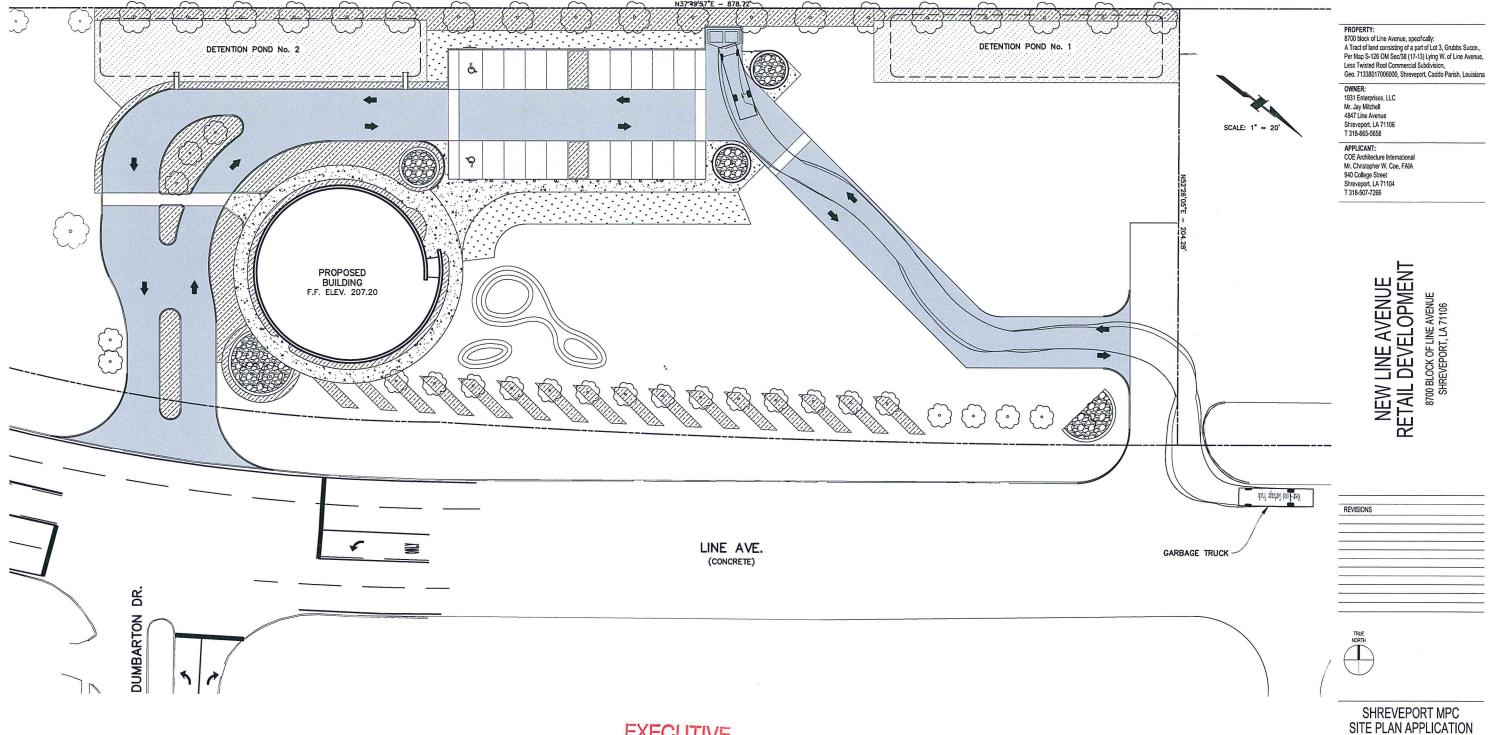

DIRECTOR APPROVAL

8-20-24 an alger Date

PRELIMINARY - NOT FOR CONSTRUCTION

THIS DOCHEM'T IS FOR INFORMATIONAL PURPOSES ONLY AND IS HOT TO BE USED FOR CONSTRUCTION.

DECEMBER, 2023

PINA HAME, BALAR ASSOCIATES, INC. DIGNEDER'S HAME. ANDREW J. VERNER, P.E.

REGISTRATION No.: 37263



BALAR ASSOCIATES, INC.
631 MILLAM STREET, SUITE 300
SHREVEPORT, LOUISLANA 71101
PHONE: 318-221-8312
FAX: 318-424-6508
E-MAIL: balar@balar-engineers.com
WEB:www.balar-engineers.com
LOUISLANA REGISTRATION NO. 64
TEXAS REGISTRATION NO. F-11221


RESERVED, NO COMPEN, INANSMISSION, ENPRODUCTIONS OR ELECTRONIC MAINTOLATION OF ANY PORTITION OF THESE DRAWINGS IN WHOLE OR IN PART ARE TO BE MADE WITHOUT THE EXPRESS WRITTEN PERMISSION OF COE ARCHITECTURE INTERNATIONAL CORP.


MPC SIGNATURE + DATE:

ALL DESIGNS INDICATED IN THESE DRAWINGS ARE THE PROPERTY OF COE ARCHITECTURE INTERNATIONAL CORP. ALL COPYRIGHTS RESERVED. NO COPIES, TRANSMISSIONS, REPRODUCTIONS OR

SHEET ISSUE DATE:

DRAWING NAME: MPC VEHICLE TRACKING PLAN 3 OF 3

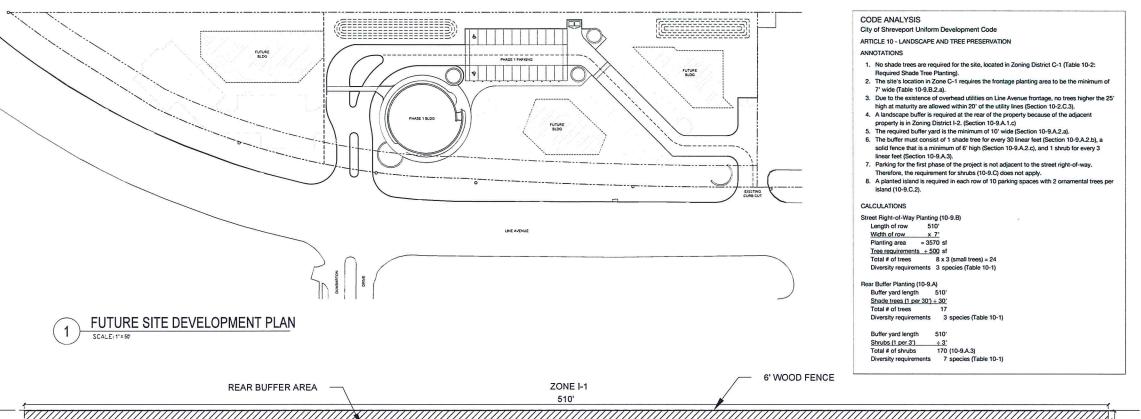

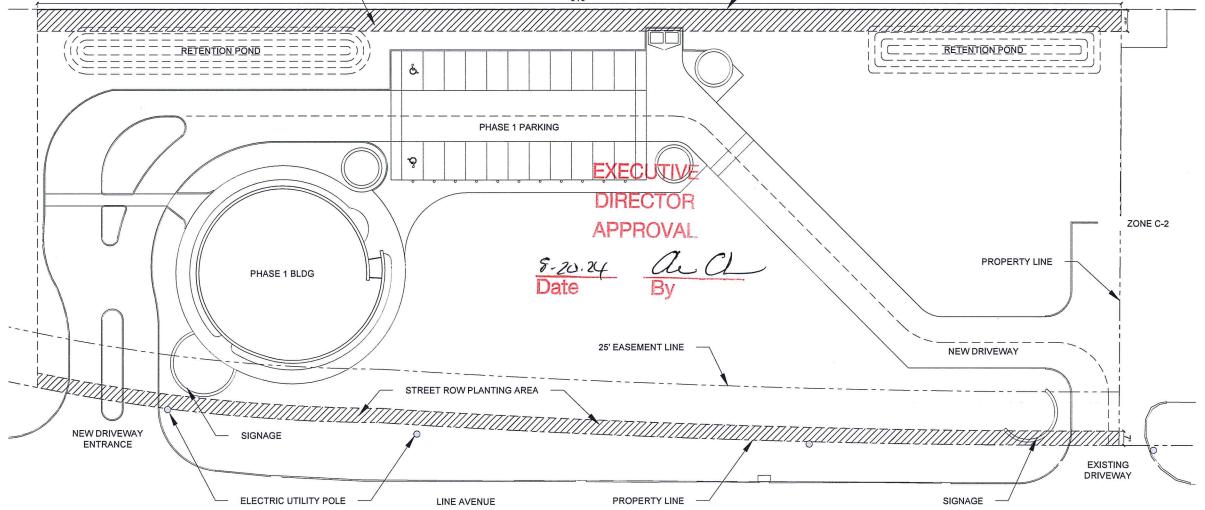



Clarkes Jewelers

8750 LINE AVENUE, SHREVEPORT, LA 71106

Architect: COE Architecture International 2303 Line Avenue Shreveport, LA 71104 T 318.570.7255

Landscape Architect: William Hartman Landscape Arch 1031 Dudley Dr Shreveport, LA 71104 T 318.525.7023

MEP Engineers:
John J. Guth Associates, Inc.
208 Mäan Street
Shreveport, LA 71101
T 318-221.6338
Civil Engineer:
Balar Associates
631 Mäam Street Suite 300
Shreveport, LA 71101
T 318-221.8321

T 318.221.8321

Structural Consultant:
Alliet, Fenner, Jolly, and McClella
3003 Knight Steet
Shreveport, LA 71105
T 318.425.7452

REVISIONS



SEAU SIGNATURE/ DATE:

PROJECT NUMBER:

TO THE BEST OF MY KNOWLEDGE AND BELIEF, THESE PLANS AND SPECIFICATIONS COMPLY WITH THE MINIUM BUILDING CODES AND THE APPLICABLE FIRE-SAFETY STANDARDS

ALL DESIGNS INDICATED IN THESE DRAWINGS ARE THE PROPERTY OF COE ARCHITECTURE INTERNATIONAL CORP. ALL COPYIGHTS RESERVED. IN COPEN TRAINISSISSIONS REPRODUCTIONS OR ELECTRONIC UMAPULATION OF ANY PORTION OF THESE DRAWINGS IN WINDLE OR IN APAT ARE TO BE ABOUT WITHOUT THE EIPERS WHITEN PERWISSION OF COE ARCHITECTURE WITERNATIONAL CORP.

SHEET ISSUE DATE: 06.28.24

DRAWI NAME:

LANDSCAPE ANALYIS PLAN

1-10



Clarkes Jewelers

8750 LINE AVENUE, SHREVEPORT, LA 71105

Landscape Architect: William Hartman Landscap 1031 Dudley Dr



MEP Engineers: John J. Guth Associates, Inc 208 Milam Street Shreveport, LA 71101 T 318,221,8638

Civil Engineer: Balar Associates 631 Milam Street, Suite 300 Shreveport, LA 71101 T 318.221.8321

Structural Consultant: Aillet, Fenner, Jolly, and McClellan, Inc. 3003 Knight Street Shreveport, LA 71105 T 318.425.7452

SEAL/ SIGNATURE/ DATE:



Rear Buffer

Rear Buffer

Rear Buffer

Rear Buffer

Rear Buffer

Rear Buffer

Rear Buffer Rear Buffer

Rear Buffer

Rear Buffer


8440 sf 4350 sf TO THE BEST OF MY KNOWLEDGE AND BELIEF, THESE PLANS AND SPECIFICATIONS COMPLY WITH THE MINIMUM BUILDING CODES AND THE APPLICABLE FIRE-SAFETY STANDARDS

ALL DESIGNS INDICATED IN THESE DRAWINGS ARE THE PROPERTY OF COE ARCHITECTURE INTERNATIONAL CORP. ALL COPYRIGHTS RESERVED, NO COPES, TRANSMISSIONS, REPRODUCTIONS OR ELECTRONIC UNAMPLICATION OF ANY PORTION OF THESE DRAWINGS IN VHOLE OR IN PART ARE TO BE MADE WITHOUT THE EXPRESS WRITTEN

SHEET ISSUE DATE: 06.28.24

LANDSCAPE PLANTING PLAN

© COE ARCHITECTURE INTERNATIONAL CORP.

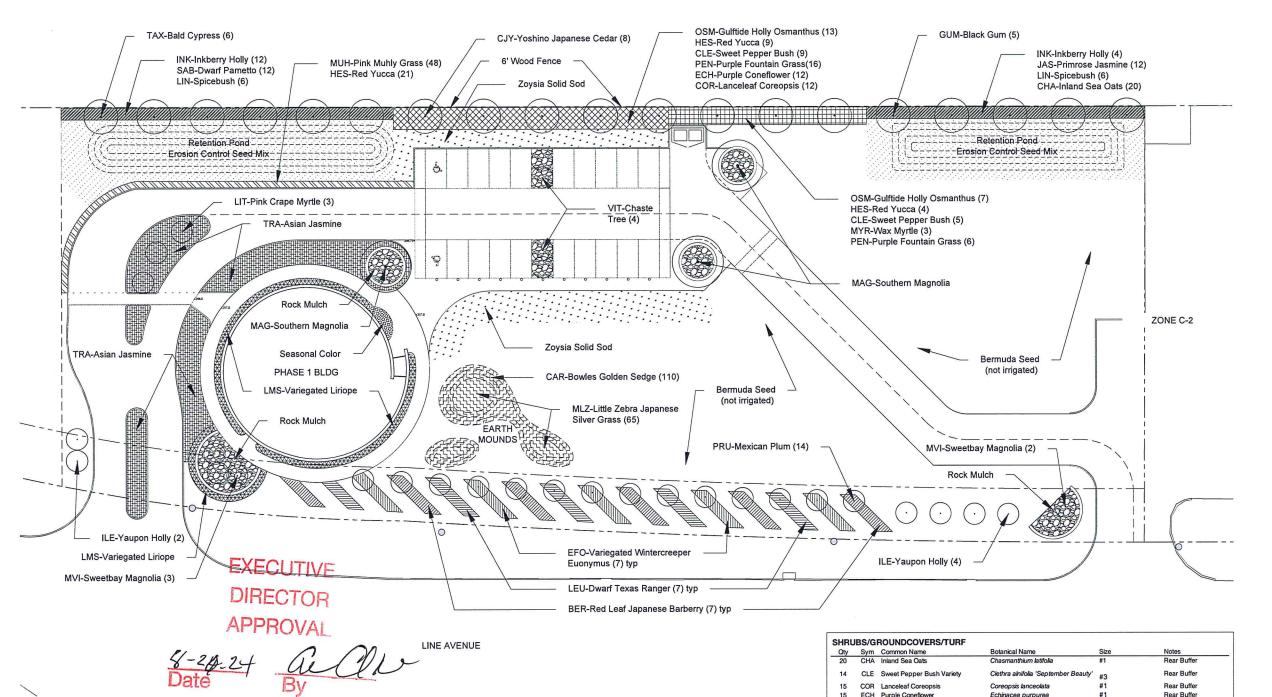

15 COR Lanceleaf Coreopsis

HES Red Yucca

LIN Spicebush

MYR Wax Myrtle

SAB Dwarf Palmetto 174 Total Shrubs at Rear Buffe

ECH Purple Coneflower

ITE Virginia Sweetspir

INK Inkberry Holly

JAS Primrose Jasmin

OSM Gulftide Holly Osmanthus

BER Red Leaf Japanese Barberi

MLZ Little Zebra Japanese Silver Grass

ERO Erosion Control Seed Mix

CAR Bowles Golden Sedge
COL Seasonal Color
EFO Variegated Wintercreep

HEM Stella de Oro Daylilly

LEU Dwarf Texas Ranger

MUH Pink Muhly Grass

ZOY Emerald Zoysia

HES Red Yucca

210 LMS Variegated Liriope

938 Total Additional Container CYN Common Bermuda

PEN Purple Fountain Grass

Coreopsis lanceolata

Echinacea purpure

Hesperaloe parvifolia

Itea virginica

Jasminum mesny

Lindera benzoin

Myrica cerifera

Carex elata 'Aurea Blooming Annuals nus Eonymus fortunei 'Emerald 'n Gold'

Hesperaloe parvifolia

Cynodon dactylon

Mixed Grass Species

Zoysia sp. 'Emerald'

Osmanthus heterophyllus 'Gulftide'

Pennisetum setaceum 'Rubrum'

Berberis thunbergii 'Atropurpurea

Hemerocallis 'Stella de Oro'

Miscanthus sinensis 'Little Zebra'

Leucophyllum frutescens 'Compacta' #5 Liriope muscari 'Silvery Sunproof'

Seeded Solid Sod

Ilex Glabra

ΡL	_AN	TING I	PLAN	
SCA	4LE:1"=	2σ		
0	10	20	40	80
1000	SESSE SESSE	Mary San		

PRELIMINARY - NOT FOR CONSTRUCTION

PLANT MATERIAL LISTS

Qty	Sym	Common Name	Botanical Name	Size		Notes
8	CJY	Yoshino Japanese Cedar	Cryptomeria japonica 'Yoshino'	5' ht	#25 cont	Rear Buffer
5	GUM	Black Gum	Nyssa sylvatica	3" cal	12'-15' ht	Rear Buffer
6	TAX	Bald Cypress	Taxodium distichum	3" cal	12'-15' ht	Rear Buffer
19	Total S	hade Trees at Rear Buffer				
6	ILE	Pride of Houston Yaupon Holly	llex vomitoria 'Pride of Houston'	8' ht	#15 cont	ROW Planting
5	MVI	Sweetbay Magnolia	Magnolia virginiana	8' ht	#15 cont	ROW Planting
14	PRU	Mexican Plum	Prunus mexicana	8' ht	#15 cont	ROW Planting
25	Total S	mall Trees at Street ROW				
3	LIT	Pink Crape Myrtle	Lagerstroemia indica 'Tuscarora'	10' ht	Multi-trunk	Driveway Median
3	MAG	Majestic Beauty Magnolia	Magnolia grandiflora 'Majestic Beauty'	#45 cont	12'-15' ht	Parking Lot Planters
4	VIT	Chaste Tree	Vitex agnus-castus	8' ht	#15 cont	Parking Lot Planters

Qty	Sym	Common Name	Botanical Name	Size		Notes
8	CJY	Yoshino Japanese Cedar	Cryptomeria japonica 'Yoshino'	5' ht	#25 cont	Rear Buffer
5	GUM	Black Gum	Nyssa sylvatica	3" cal	12'-15' ht	Rear Buffer
6	TAX	Bald Cypress	Taxodium distichum	3" cal	12'-15' ht	Rear Buffer
19	Total S	hade Trees at Rear Buffer				
6	ILE	Pride of Houston Yaupon Holly	llex vomitoria 'Pride of Houston'	8' ht	#15 cont	ROW Planting
5	MVI	Sweetbay Magnolia	Magnolia virginiana	8' ht	#15 cont	ROW Planting
14	PRU	Mexican Plum	Prunus mexicana	8' ht	#15 cont	ROW Planting
25	Total S	mall Trees at Street ROW				
3	LIT	Pink Crape Myrtle	Lagerstroemia indica 'Tuscarora'	10' ht	Multi-trunk	Driveway Median
3	MAG	Majestic Beauty Magnolia	Magnolia grandiflora 'Majestic Beauty'	#45 cont	12'-15' ht	Parking Lot Planters
4	VIT	Chaste Tree	Vitex agnus-castus	8' ht	#15 cont	Parking Lot Planters

GENERAL NOTES

- 1. These plans reflect the scope of the Landscape Architect external services. For Architectural, Civil please refer to the appropriate consultant documents
- 2. The locations of plants, as shown in these plans, are approximate. The final locations may be adjusted to accommodate unforeseen field conditions to comply with safety criteria, to avoid creating unsafe sight conditions, or as otherwise directed by or approved by the landscape architect or owner's representative.
- 3. Construction shall comply with all local building codes.
- 4. If a discrepancy should arise between layout geometry and design intent, design intent shall take

GENERAL GRADING NOTES

- 1. Rough grading and site preparation shall be completed for review by Landscape Architect / or esentative prior to final grading.
- 2. Grading and calculations for retention areas to be provided by Civil Engineers.
- 3. All graded areas shall be dragged with a drag mat or hand rakel to blend in small imperfections and round off any sharp lines that may have been constructed by equipment. All areas to be planted shall have no water holding pockets.

GENERAL LANDSCAPE NOTES

- 1. The Contractor shall be responsible for verifying all underground utilities prior to digging in any area. The contractor shall notify all necessary utility companies 48 hours minimum prio digging for verification of all underground utilities, irrigation and all other obstructions and coordinate with Owner's Representative prior to initiating operations. Drawings are prepared according to the best information available at the time of preparing documents
- 2. The contractor is responsible to ensure proper watering and maintenance of new and relocated plant materials during the one year warranty period.
- 3. Contractor is to report any discrepancies between the construction drawings and field conditions to the Owner's Representative immediately.
- 4. Landscape Contractor shall coordinate all work with related contractors and with the general construction of the project in order not to impede the progress of the work of others or the contractor's own work. Landscape contractor shall provide schedule of his/her work two weeks in advance, beginning two weeks prior to commencing landscape trade construction.
- 5. The Contractor shall bear all costs of testing of soils, amendments, etc. associated with the work, Prior to commencement of the landscape planting work the Contractor shall provide complete soil tests with recommendations for soil treatment in the construction area
- 6. Landscape Contractor shall field stake the location of all plant material or field stake the plants prior to initiating installation for the review and approval of the Owner's representative and/or Landscape Architect. Note: No planting shall commence until there is a functional irrigation system in the area to be planted. No trees shall be planted on top of irrigation lines.
- 7. Landscape Contractor shall field adjust location of plant material as necessary to avoid damage to all existing underground utilities and/ or existing above ground elements. All changes required shall be completed at the Contractor's expense and shall be coordinated with Owner's Representative and the Landscape Architect
- 8. Any substitutions in size and/or plant species must be approved by the Landscape Architect or Owner's Representative prior to modification of the contract, purchasing and delivery of plants. All plants will be subject to approval by Landscape Architect and/or Owner's Representative
- Landscape Contractor shall coordinate all planting work with permanent or temporary irrigation
 work, Landscape Contractor shall be responsible for all hand watering as required by Owner's Representative to supplement irrigation watering and rainfall. Landscape Contractor shall be responsible for hand watering in all planting areas, regardless of the status of existing or proposed irrigation.
- 10. Landscape Contractor shall clean the work areas at the end of each working day. Rubbish and debris shall be collected and deposited off-site or in an approved disposal area daily. All materials, products and equipment shall be stored in an organized fashion as directed by the
- 11. Guying/staking shall not permit nails, screws, wires, etc., to penetrate outer surface of any tree. Tree rejuected due to this practice shall be replaced at the Contractor's expense.
- 12. Burlap material, wire cages, plastic straps, etc., must be cut and removed from top one-third
- 13. Trees grown in grow bags or grow bag type material are not allowed.
- 14. All planting materials shall meet or exceed local requirements as specified by local plant
- 15. All landscape installations shall meet or exceed the minimum requirements as shown in appropriate municipal codes.
- 16. The Contractor shall be responsible for the guarantee of all plant material for a period of twelve (12) months from the date of substantial completion. Substantial completion constitutes the beginning of quarantee period
- 17. Plant size specifications take precedence over container size.
- 18. Contractor to verify quantities and report any discrepancies to Owner's representative and/or
- 19. All proposed planting beds will be planted out correctly with proper spacing.


SOIL PREPARATION AND SOIL MIX

- 1. Plant holes should be dug and the sides and bottom of the hole should be stable, regardless of denth. Soil scarification is necessary if sides of the hole are compacted
- 2. Contractor to apply approved pre-emergent herbicide in accordance with manufacturer's rate and specifications. Contractors to provide manufacturer's specifications for approval
- 3. Planting soil mix for planters, trees, shrubs, and ground cover & grasses shall be determined by
- 4. The planting soil mix should be what comes out of the hole so the plant adapts to the surrounding/existing soil and grows into it. This is why the sides and the bottom of the planting hole should never be compacted with the digging implements. Never fertilize newly planted plants and trees. Please note that peat moss will eventually decompose and clog soil pores thereby inhibiting the plants water and oxygen consumption.
- 5. Topsoil shall be natural, fertile, agricultural soil capable of sustaining vigorous plant growth. It shall be of uniform composition throughout, with admixture of subsoil, it shall be free of stones, lumps, live plants and their roots, sticks, and other extraneous material. Top soil brought in should match as well as possible the existing soil texture and Ph. Planted material should never be "mounded" or raised: the soil will eventually wash away exposing the roots and it will be difficult to establish the plant material due to drought and excessive soil transpiration. All plant/free material should be installed with the root collar exposed (approximately 1/2" to1"). Landscape contractor should find the uppermost lateral root and plant that just below the soil
- 6. Smooth topsoil without compaction to two inches (2") below finish grade in areas to be sodded
- 7. Finish grade all topsoil areas to a smooth non-compacted, even surface assuring positive drainage away from the structures and eliminate any low areas except in retention areas where
- 8. Contractor to remove debris and excess material immediately from job site while keeping in mind that heavy equipment will compact soil to the detriment of water drainage and the health of the newly installed plants. All planting areas with compacted soil will have surfaces scarified to a

PLANTING SPECIFICATIONS


- 1. The contractor is responsible for maintaining, in full, all planting areas (including watering, spraying, mulching, mowing, fertilizing, etc.) Until the job is accepted, in full, by the owner, its representative and Landscape Architect.
- 2. All plant material shall be protected during transport and delivery to final location with shade cloth or other acceptable means of windburn prevention. Plant/tree material shall conform to ANSI Z60, published by American Horticulture Industry Association.
- 3. All trees 30 gallons or larger must be guyed or staked as shown in details.
- 4. When plant material is delivered onsite, it shall not be laid down for more than two hours. Plant material when stored onsite shall be placed and maintained in good condition in a vertical position, All plants held onsite shall be kept watered regularly in sufficient amounts to permit continuous and vigorous growth.
- 5. Installation of all plant material shall be installed in a sound, workmanlike manner and according to accepted good planting and tree relocation procedures with the quality of plant materials as hereinafter described. All elements of landscaping shall be installed so as to meet all applicable
- 6. There shall be no chains or cables used directly on trees, handle with 2" minimum width nylon straps or equal.
- 7. Contractor shall assure drainage and percolation of all planting pits. Prior to installation of plant material, contractor shall fill all tree pits with water before planting to assure that proper drainage and percolation is available. Correct if required to assure percolation. Contractor is responsible for replacement of all plants lost due to inadequate drainage conditions. Plant/tree material that has bark scraped off due to shipping, handling, and installation issues may be rejected upon
- 8. Contractor to request inspection of project in writing. If all work is satisfactory and complete in accordance with conditions of contract documents, then the owner, its representative, and landscape architect shall declare the project substantially complete.
- Substantial completion constitutes the beginning of guarantee period.
- 10. Contractor to replace rejected plant within two (2) weeks of notice.
- 11. Crown pruning of any trees is generally not approved by the national arborist association standards. When it is approved, it must be done in writing.

EXECUTIVE DIRECTOR

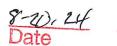







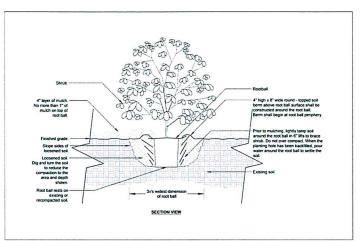

SHRUB PLANTING DETAIL

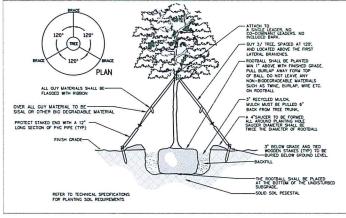

SMALL TREE PLANTING DETAIL

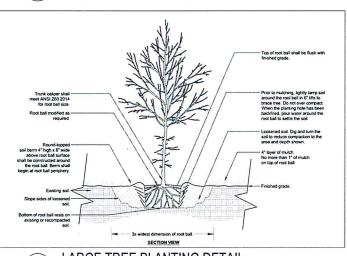

PRELIMINARY - NOT FOR CONSTRUCTION

LARGE TREE PLANTING DETAIL



Clarkes Jewelers

8750 LINE AVENUE, SHREVEPORT, LA 71106

COE Architecture Intern 2303 Line Avenue Shreveport, LA 71104 T 318.570.7266

Shreveport LA 71104 T 318,525,7023



MEP Engineers: John J. Guth Associates, Inc. 208 Milam Street Shreveport, LA 71101 Shreveport, LA 7 T 318,221,8638

Civil Engineer: Balar Associates 631 Milam Street, Suite 300 Shreveport, LA 71101 T 318.221.8321

Structural Consultant Aillet, Fenner, Jolly, and McClellan, Inc. Shreveport, LA 71105 T 318.425.7452

REVISIONS



SEAL/ SIGNATURE/ DATE:

PROJECT NUMBER:

TO THE BEST OF MY KNOWLEDGE AND BELIEF, THESE PLANS AND SPECIFICATIONS COMPLY WITH THE MINIMUM BUILDING CODES AND APPLICABLE FIRE-SAFETY STANDARDS

ALL DESIGNS INDICATED IN THESE DRAWINGS ARE THE PROPERTY OF ALL DESIGNS BILLAL FOR INTERS BROWNING SARE THE PROPERTY OF COE ARCHITECTURE INTERNATIONAL CORP. ALL COPYRIGHTS RESERVED, NO COPIES. TRANSMISSIONS, REPRODUCTIONS OR ELECTRONIC MAINFULFATION OF ANY PORTION OF THESE DRAWINGS IN WHOLE OR IN PART ARET OR BE MORE WITHOUT THE EXPRESS WRITTEN PERMISSION OF COE ARCHITECTURE INTERNATIONAL CORP.

SHEET ISSUE DATE: 06.28.24

LANDSCAPE NOTES AND PLANTING DETAILS

Clarkes Jewelers

8750 LINE AVENUE, SHREVEPORT, LA 71106


Architect: COE Architecture Intern 2303 Line Avenue Shreveport, LA 71104 T 318.570.7266

T 318,525,7023

MEP Engineers: John J. Guth Associates, Inc. 208 Miam Street Shreveport, LA 71101 T 318.221.8638

Civil Engineer: Balar Associates 631 Milam Street, Suite 300 Shreveport, LA 71101 T 318.221.8321

Structural Consultant: Aillet, Fenner, Jolly, and McClellan, Inc 3003 Knight Street Shreveport. LA 71105 T 318.425.7452

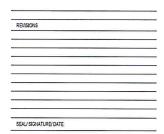



PROJECT NUMBER:

TO THE BEST OF MY KNOWLEDGE AND BELIEF, THESE PLANS AND SPECIFICATIONS COMPLY WITH THE MINIMUM BUILDING CODES AND THE APPLICABLE FIRE-SAFETY STANDARDS

ALL DESIGNS INDICATED IN THESE DRAWINGS ARE THE PROPERTY OF COE ARCHITECTURE INTERNATIONAL CORP. ALL COPYRIGHTS RESERVED. NO COPIES, TRANSMISSIONS, REPRODUCTIONS OR ELECTRONIC MANIPULATION OF ANY PORTION OF THESE DRAWINGS IN WHOLE OR IN PART ARE TO BE MADE WITHOUT THE EXPRESS WRITTEN

SHEET ISSUE DATE: 06.28.24


LANDSCAPE IRRIGATION PLAN

L-3.0


EXECUTIVE

DIRECTOR

James Pole

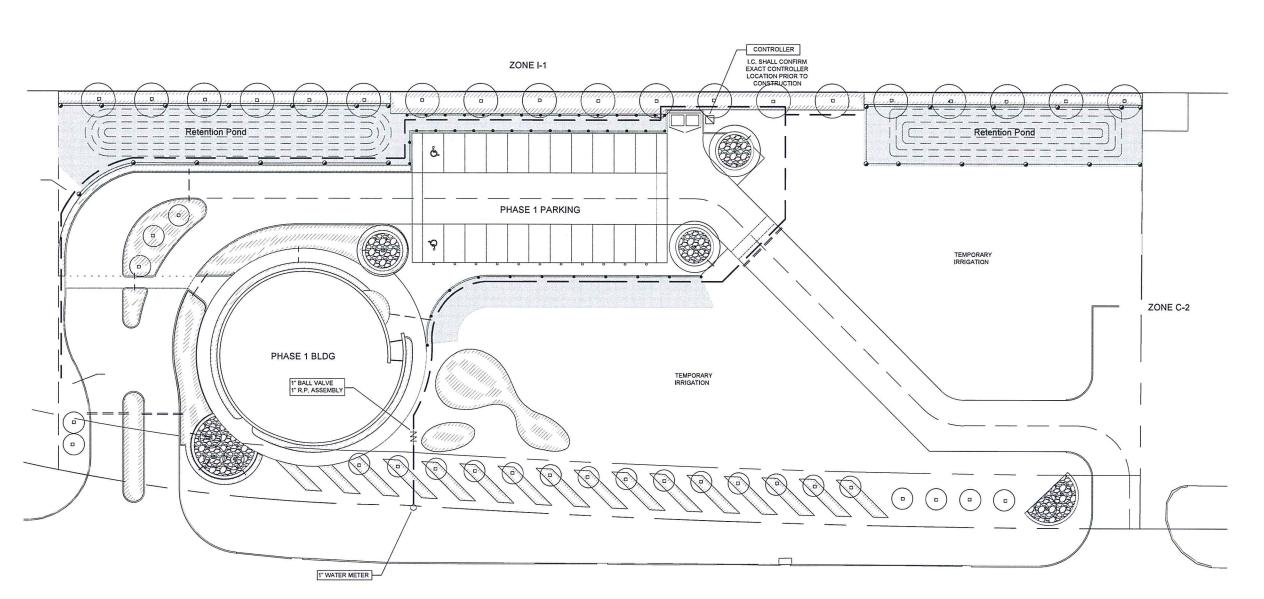

LINE AVENUE

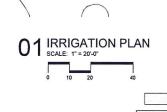

AREAS TO RECEIVE PERMANENT IRRIGATION

TEMPORARY IRRIGATION

THE CONTRACTOR SHALL COORDINATE WITH THE PLANTING PLAN AND PROVIDE TEMPORARY IRRIGATION FOR THE ESTABLISHMENT OF ALL PROPOSED PLANT MATERIALS LOCATED OUTSIDE THE LIMITS OF COVERAGE PROVIDED BY THE PERMANENT SYSTEM.

HYDROZONING

IRRIGATION SYSTEM SHALL BE HYDRO-ZONED IN A MANOR THAT KEEPS PLANT MATERIALS WITH SIMILAR WATER REQUIREMENTS ON THE SAME ZONES, IRRIGATION ZONES SHALL ACCOUNT FOR HIGH, MEDIUM, LOW WATER USE AS WELL AS TOPOGRAPHY AND SUN / SHADE

IRRIGATION LEGEND

HUNTER PROS-06-PRS30 SERIES POP UP SPRAY HEADS WITH HUNTER MSBN-50H STREAM BUBBLER NOZZLES. (TWO PER TREE)
SEE INSTALLATION NOTE #13 REGARDING TREE BUBBLER LATERAL PIPE
HUNTER RXXW ROOT WATERING SYSTEM MODEL RXWS-10-50-CV WITH RZWS-SLEEVE. (TWO PER TREE)
SEE INSTALLATION NOTE #13 REGARDING TREE BUBBLER LATERAL PIPE
HUNTER PROS-04-PRS30 SERIES POP UP SPRAY HEAD WITH PRO SPRAY SERIES NOZZLE AS NOTED BELOW
HUNTER PROP ULTRA, ADJUSTABLE ARC 4" POP UP ROTARY HEAD, PART CIRCLE, #2.5 BLUE NOZZLE UNLESS NOTED OTHERWISE
NETAFIM TECHLINE TLHCVXRS-12 SERIES DRIP TUBE IN SHRUB BED INSTALLED AT 2" DEPTH
SEE INSTALLATION NOTE #16 REGARDING DRIP TUBE LAYOUT IN SHRUB BEDS.
HUNTER ICV SERIES ELECTRIC REMOTE CONTROL VALVE 0 HUNTER ICV SERIES ELECTRIC REMOTE CONTROL, "TREE BUBBLER ZONE" VALVE
SEE INSTALLATION NOTE #13 REGARDING TREE BUBBLER LATERAL PIPE
NETAFIM CONTROL ZONE KIT MODEL #NCZ-1S SERIES WITH 50 PSI PRESSURE REGULATOR AND SCREEN FILTER


HUNTER HO-33DLRC-R QUICK COUPLING VALVE WITH LOCKING PURPLE COVER AND 3/4" PVC BALL VALVE
ZURN / MILKINS 375XLB SERIES REDUCED PRESSURE TYPE BACKFLOW PREVENTOR INSTALLED PER CITY CODE
WITH HEATED INSULATED ALUMINUM ENCISOURE AND SAME SIZE BRONZE BALL VALVE INSTALLED ON THE UP-STREAM SIDE.
G.C. TO COORDINATE POWER TO BACKFLOW ENCLOSURE LOCATION PRIOR TO CONSTRUCTION IRRIGATION WATER METER AND TAP, SIZE AS NOTED ON THE PLAN
HUNTER HYDRAWISE HCC SERIES AUTOMATIC CONTROLLER MODEL #HCC-800-M WITH WIFI-EXT-KIT, AND


RAIN / FREEZE SENSOR, LOCATE SENSOR AS FIELD DIRECTED BY THE LANDSCAPE ARCHITECT CLASS 200 PVC MAINLINE PIPE


CLASS 200 (EXCEPT 1/2 INCH #315) PVC LATERAL PIPE - ONE 4" CLASS 200 SLEEVE PIPE


= = TWO 4" CLASS 200 SLEEVE PIPES


I.C. SHALL SELECT SPRAY NOZZLES FOR "HEAD-TO-HEAD" COVERAGE, ADJUSTED FOR NO OVERSPRAY ONTO WALLS AND WALKS. NO OVERSPRAY INTO STREETS IS PERMITTED.

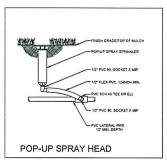


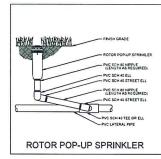


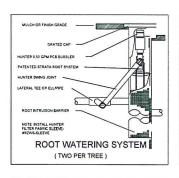


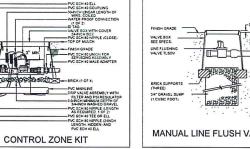


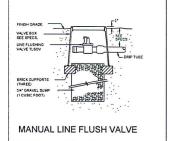

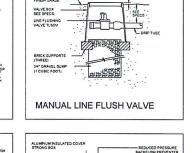


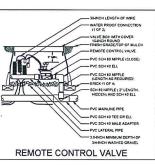


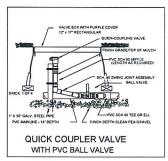


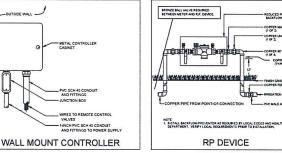


WRING IN

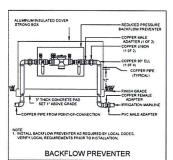

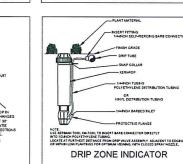

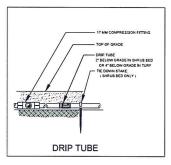

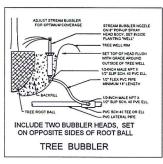

MANUAL LINE FLUSHING VALV

CONNECTION

DRIP LINE START


PERIMETER LATERAL

REMOTE CONTROL
VALVE WITH DISC
FILTER AND PRV


SUPPLY AND EXHAUST HEADERS SHALL BE CLASS 200 PVC PIPE, OF THE SAME DIAMETER AS THE ZONE VALVE SIZE.


DRIP TUBE FOR SUPPLY AND EXHAUST HEADERS ON GRIDS WITH FLOW SMALLER THAN 5 GPM ONLY.


DRIP CENTER FEED LAYOUT

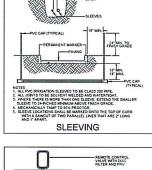

DRIP END FEED LAYOUT

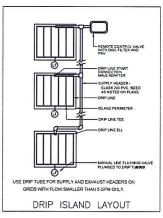

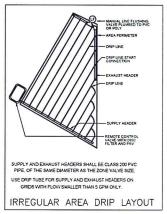

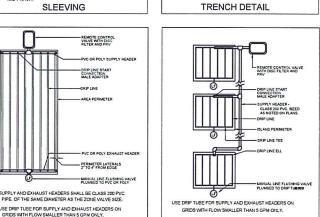

1. SLEEVE BELL TWICE THE D

MANLINE LATERAL MAINLINE LATERAL AND WRING IN PIPE PIPE

EXECUTIVE



INSTALLATION NOTES

COORDINATE IRRIGATION INSTALLATION WITH PLANTING PLAN AND SITE CONDITIONS TO PROVIDE COMPLETE. COVERAGE WITH COURNIALE INMIGATION INSTALLATION WITH FLANTING PLAY AND STEED OF PROVIDE COMPLETE. COVERAGE WITH MINIMUM OVERSPRAY. THE IRRIGATION CONTRACTOR SHALL MAKE MINOR ADJUSTMENTS TO. ENSURE PROPER COVERAGE AT NO ADDITIONAL COST TO THE OWNER. THE IRRIGATION CONTRACTOR SHALL COMPLY WITH ALL LOCAL AND STATE MANDATED IRRIGATION CONTRACTOR SHALL COMPLY WITH ALL LOCAL AND STATE MANDATED IRRIGATION CONDINANCES AND CODES, AND WILL SECURE ALL REQUIRED PERMITS. I.C. SHALL PAY NY ASSOCIATED FEES UNLESS OTHERWISE NOTED. ALL LOCAL CODES SHALL PREVAIL OVER ANY DISCREPANCIES HEREIN AND SHALL BE ADDRESSED BEFORE ANY CONSTRUCTION BEGINS.

ADDRESSED BEFORE ANY CONSTRUCTION BEGINS.

NO MACHINE TRENCHING SHALL BE PERMITTED WITHIN THE ROOT ZONE OF EXISTING TREES. HAND-DIG ONLY, WITHIN THE ROOT ZONES OF EXISTING TREES. HONCHING TREEN SHALL BE PERMITTED WITHIN THE ROOT ZONE OF EXISTING TREES. HAND-DIG ONLY, WITHIN THE ROOT ZONES OF EXISTING TREES FOR APPROVAL BY THE LANDSCAPE ARCHITECT BEFORE DIGGING BEGINS.

CONFIRM MINIMUM STATIC WATER PRESSURE OF 69 PS.I. AT THE LOWEST ELEVATION OF THE SYSTEM LIMITS, AND MAXIMUM STATIC WATER PRESSURE OF 69 P.S.I. AT THE LOWEST ELEVATION OF THE SYSTEM LIMITS AT LEAST 7 DAY'S BEFORE BEGINNING WORK. IF STATIC WATER PRESSURE IS OUTSIDE THE RANGE STATED ABOVE. DO NOT PROCED UNTIL DIRECTED BY THE LANDSCAPE ARCHITECT.

LATERAL PIPE SHALL BE INSTALLED AT A MINIMUM DEPTH OF 12 INCHES. MAINLINE PIPE AND WIRES SHALL BE INSTALLED AT A MINIMUM DEPTH OF 18 INCHES. NO MACHINE TRENCHING SHALL BE PERMITTED WITHIN EXISTING TREE ROOT ZONES. WHEN HAND. TRENCHING WITHIN EXISTING TREE ROOT ZONES. OR ROOTS LARGER THAN 1° DIAMETER SHALL BE CUT. IRRIGATION PLANS ARE DIAGRAMMATIC ONLY. IRRIGATION EQUIPMENT MAY BE SHOWN IN IMPERVIOUS SUFFACES FOR GRAPHIC CLARITY PURPOSES. I.C. SHALL MAKE MINOR ADJUSTMENTS, AT NO ADDITIONAL COST TO THE OWNER, OF THE LOCATIONS OF THE INCREDITED FOR APPROVAL OF CHANGES. UNSLEEVED PIPES MAY BE SHOWN UNDER PAVEMENT FOR GRAPHIC CLARITY ONLY. INSTALL THESE PIPES IN ADJACENT LANDSCAPED AREAS. PIPES IN ADJACENT LANDSCAPED AREAS.

ELECTRIC POWER SHALL BE PROVIDED WITHIN FIVE FEET OF CONTROLLER LOCATION BY GENERAL CONTRACTOR. I.C. TO PROVIDE FINAL HARD-WIRE TO CONTROLLER.

24 VOLT VALVE WIRE SHALL BE A MINIMUM OF #14 GAUGE, U.F. APPROVED FOR DIRECT BURIAL SINGLE CONDUCTOR

6. ELECTRIC POWER SHALL BE PROVIDED WITHIN FIVE FEET OF CONTROLLER LOCATION BY GENERAL CONTRACTOR. I.C., TO PROVIDE FINAL HARDWIRE TO CONTROLLER.
7. 24 VOLT VALVE WIRE SHALL BE A MINIMUM OF #14 GAUGE. U.F. APPROVED FOR DIRECT BURIAL, SINGLE CONDUCTOR TRIGIGATION WIRE: WIRE SPLICES SHALL INCLUDE DBY CONNECTORS AS MANIFACTURED BY 3M COMPANY. ALL FIELD SPLICES SHALL BE LOCATED IN A ROUND VALVE BOX OF SUFFICIENT SIZE TO ALLOW INSPECTION.
8. VALVE BOXES SHALL BE INSTALLED FLUSH WITH GRADE, SUPPORTED BY BRICKS F NEEDED, WITH 31 INCHES OF CLEAN PEA GRAVEL LOCATED BELOW THE VALVE. USE 12" x 17" RECTANGULAR VALVES INCHES ON THE 18" DECIDIOR OF COUNTY OF THE VALVES, AND 10" ROUND BOXES FOR ELECTRIC VALVES UNLESS NOTED OTHERWISE. D.C.A. WITH UPSTREAM BALL VALVE AND WIFFILTER SHALL BE BOXED AND LOCATED ACCORDING TO LOCAL CODE.
9. USE RIGID SCH, 80 PVO SYMMS JOINT ASSEMBLES TO CONNECT ALL ROTARY HEADS AND QUICK COUPLERS.
10. ALL SPRAY HEADS SHALL BE CONNECTED WITH A 12" MINIMUM LENGTH OF 1/2" FLEX PVC. THE FLEX PVC SHALL BE SOLVENT WELDED TO SCHEDULE 40 PVC FITTINGS WITH WELD ON WITH STREAM BALL VALVE AND WELDED TO SCHEDULE 40 PVC FITTINGS WITH WELD ON WITH SWELD FOR STREAM STREA

CONNECTIONS, SET I THE MAXIMUM OPERATING PRESSURE AT 50 PSI. TECHLINE CV SHALL BE INSTALLED PERPENDICULAR TO
SLOPE FACE. INSTALL IT.CV IN-LINE CHECK VALVES FOR EVERY 4.5 FEET OF DRIP UNE ELEVATION CHANGE WITHIN THE ZONE.
EACH DRIP ZONE SHALL INCLUDE ONE MAINTENANCE "FLAC WHICH SHALL CONSIST OF A 12" POP-UP SPRAY HEAD AND
COMPLETELY CLOSED SPRAY NOZZLE. THE POP-UP HEAD SHALL BE CONNECTED TO THE DRIP POPP. SET FLUSH WITH
GRADE. AND LOCATED AT THE FARTHEST DISTANCE FROM THE DRIP VALVE ASSEMBLY. INSTALL THE "FLAG" HEAD ADJACENT TO
EDGINS OR IN LOW PLANTINGS FOR EASE OF VIEWING. TEMPORARY SUPPLEMENTAL OVERHEAD WAYERING MAY BE REQUIRED
FOR INITIAL ESTABLISHMENT OF NEW SOD, SEEDED TURF, OR SEEDED NATIVE MIX AREAS SERVED BY SUB-SURFACE DRIP
FOUNDMENT.

IRRIGATION LEGEND

0	HUNTER PROS-06-PRS30 SERIES POP UP SPRAY HEADS WITH HUNTER MSBN-50H STREAM BUBBLER NOZZLES. (TWO PER TREE)
	SEE INSTALLATION NOTE #13 REGARDING TREE BUBBLER LATERAL PIPE
8	HUNTER RZWS ROOT WATERING SYSTEM MODEL RZWS-10-50-CV WITH RZWS-SLEEVE. (TWO PER TREE)
	SEE INSTALLATION NOTE #13 REGARDING TREE BUBBLER LATERAL PIPE
•	HUNTER PROS-04-PRS30 SERIES POP UP SPRAY HEAD WITH PRO SPRAY SERIES NOZZI E AS NOZED BELOW

HUNTER PROSURE THOSE SERIES POUP OF STATE THEM WITH PRO SPRAT SERIES NOZZLE AS NOTED BELOW HUNTER PGP ULTRA, ADJUSTABLE ARC 4" POP UP ROTARY HEAD, PART CIRCLE, #2.5 BLUE NOZZLE UNLESS NOTED OTHERWISE NETAFIM TECHLINE TLHCVXR5-12 SERIES DRIP TUBE IN SHRUB BED INSTALLED AT 2" DEPTH SEE INSTALLATION NOTE #16 REGARDING DRIP TUBE LAYOUT IN SHRUB BEDS.

HUNTER ICV SERIES ELECTRIC REMOTE CONTROL VALVE

HUNTER ICV SERIES ELECTRIC REMOTE CONTROL "TREE BUBBLER ZONE" VALVE
SEE INSTALLATION NOTE #13 REGARDING TREE BUBBLER LATERAL PIPE
NETAFIM CONTROL ZONE KIT MODEL #NCZ-1S SERIES WITH 50 PSI PRESSURE REGULATOR AND SCREEN FILTER

ONE 4" CLASS 200 SLEEVE PIPE

HUNTER NO-33DLRC-R QUICK COUPLING VALVE WITH LOCKING PURPLE COVER AND 3/4" PVC BALL VALVE

ZURN/WILKINS 375XLB SERIES REDUCED PRESSURE TYPE BACKFLOW PREVENTOR INSTALLED PER CITY CODE

WITH HEATED / INSULATED ALUMINUM ENCLSOURE AND SAME SIZE BRONZE BALL VALVE INSTALLED ON THE UP-STREAM SIDE.
GC. TO COORDINATE POWER TO BACKFLOW BROLOSSURE LOCATION PRIOR TO CONSTRUCTION

IRRIGATION WATER METER AND TAP, SIZE AS NOTED ON THE PLAN HUNTER HYDRAWISE HCC SERIES AUTOMATIC CONTROLLER MODEL #HCC-800-M WITH WIFI-EXT-KIT AND RAIN / FREEZE SENSOR. LOCATE SENSOR AS FIELD DIRECTED BY THE LANDSCAPE ARCHITEC CLASS 200 PVC MAINLINE PIPE
CLASS 200 (EXCEPT 1/2 INCH #315) PVC LATERAL PIPE = = TWO 4" CLASS 200 SLEEVE PIPES I.C. SHALL SELECT SPRAY NOZZLES FOR "HEAD-TO-HEAD" COVERAGE, ADJUSTED FOR NO OVERSPRAY ONTO WALLS AND WALKS. NO OVERSPRAY INTO STREETS IS PERMITTED.



Clarkes Jewelers

8750 LINE AVENUE, SHREVEPORT, LA 71106

1031 Dudley Dr Shreveport, LA 71104 T 318,525,7023



Shreveport LA 71101 T 318,221,8638

T 318.221.8321

Structural Consultant Aillet, Fenner, Jolly, and McClellan, Inc 3003 Knight Street Shreveport, LA 71105 T 318.425.7452

REVISIONS		
	_	_



SEAL/SIGNATURE/DATE

PROJECT NUMBER:

TO THE BEST OF MY KNOWLEDGE AND BELIEF. THESE PLANS AND PECIFICATIONS COMPLY WITH THE MINIMUM BUILDING CODES AND THE PPLICABLE FIRE-SAFETY STANDARDS

ALL DESIGNS INDICATED IN THESE DRAWINGS ARE THE PROPERTY OF ACCESSIONS BULLACE BY THESE DEVINENCES ARE HE PROPERLY
COE ARCHITECTURE INTERNATIONAL CORP. ALL COPYRIGHTS
RESERVED. NO COPIES, TRANSMISSIONS, REPRODUCTIONS OR
ELECTRONIC MANIPULATION OF ANY POSTTON OF THESE DRAWN
WHOLE OR IN PART ARE TO BE MADE WITHOUT THE EXPRESS WR
PERMISSION OF COE ARCHITECTURE INTERNATIONAL CORP.

SHEET ISSUE DATE: 06.28.24

LANDSCAPE IRRIGATION



P.O. BOX 1845 DENTON, TEXAS 76202

SBX

SC

SITE PLAN ELECTRICAL

SC

SBX

SBX SBX

SEO• •OSE

1"=20'-0"	N

SB SB SSB

		LIGHTING FI	XTURE	SCH	EDULE
MARK	MANUFACTURER	CATALOG NO.	LAMP	MTG.	REMARKS
SA	ACOLYTE BL LIGHTING	RB-90-SWDR20-6.030- (8')-AS13-DRV-W-2460 ELVMLV BLFLEXFORMD1-4000KIP65	L.E.D. 129 LUMENS PER FOOT	COVE	LE.D. RIBBON LIGHT. 6.0W/FT. 700 LUMENS/FT. 3000K COLOR TEMPERATURE. LOW PROFILE EXTRUDED ALUMINUM SURFACE CHANNEL WITH ROUND OPAL LENS. 60W DRIVER. MOUNT IN COVE.
SB	HYDREL	ASPENBRP180CRI40K12055 DEGFLCKMSTK	L.E.D. 1007 LUMENS	SPIKE MOUNTED	ACCENT FLOOD LIGHT COMPLETE WITH ALUMINUM HOUSING, KNUCKE, ALUMINUM REFLECTOR WITH S5" DISTRIBUTION, ELECTRONIC DIMMING DRIVER, INTEGRAL HEAT SINK AND MOUNTING ACCESSORIES AS REQUIRED. LUMINIAIRE SHALL BE UL LISTED FOR WET LOCATIONS.
SC	BEGA	77–263	L.E.D. 132 LUMENS	GRADE	27" BOLLARD COMPLETE WITH DIE CAST ALUMINUM HOUSING, ELECTRONIC DIMMING DRIVER, INTEGRAL HEAT SINK, SHIELDED POLYCARBONATE DIFFUSER, ANODIZED ALUMINUM REFLECTOR AND MOUNTING ACCESSORIES AS REQUIRED. LUMINAIRE SHALL BE UL LISTED FOR WET LOCATIONS.
SD	BEGA	77–221	L.E.D. 645 LUMENS	GRADE	39" BOLLARO COMPLETE WITH DIE CAST ALUMINUM HOUSING, ELECTRONIC DIMMING DRIVER, INTEGRAL HEAT SINK, SHIELDED POLYCARBONATE DIFFUSER, ANODIZED ALUMINUM REFLECTOR AND MOUNTING ACCESSORIES AS REQUIRED. LUMINAIRE SHALL BE UL LISTED FOR WET LOCATIONS.
SE	BEGA	77–520	L.E.D. 7881 LUMENS	POLE	AREA LIGHTING FIXTURE COMPLETE WITH DIE CAST ALUMINUM HOUSING, CLEAR ACRYLIC DIFFUSER, ANDDIZED ALUMINUM REFLECTOR, ELECTRONIC DIMMING DRIVER, INTEGRAL HEAT SINK, 20' ROUND STEEL POLE AND MOUNTING ACCESSORIES AS REQUIRED. LUMINAIRE SHALL BE UL LISTED FOR WET LOCATIONS.
SF	AMERICAN ELECTRIC	ATBMP05MV0LTR35KHSS	L.E.D. 9366 LUMENS	POLE	AREA LIGHTING FIXTURE COMPLETE WITH DIE CAST ALUMINUM HOUSING, LED ARRAY, ELECTRONIC DRIVER, INTEGRAL HEAT SINK, 20' WOOD POLE AND MOUNTING ACCESSORIES AS REQUIRED. LUMINAIRE SHALL BE UL LISTED FOR WET LOCATIONS.

SB SB SB

FUTURE

BLDG

EXECUTIVE

DIRECTOR

8-20-24 ac ale Date By

PHASE 1 PARKING

	ELECTRICAL SYMBOLS
SYMBOL	DESCRIPTION
~ (POLE MOUNTED FLOOD LIGHTING FIXTURE
↔ □	POLE MOUNTED LIGHTING FIXTURE
≪	FLOOD LIGHTING
Ø	BOLLARD - SIZE AS INDICATED



PROPERTY:

PROPERTY:
6700 block of Line Avenue, specifically:
A Tract of land consisting of a part of Lot 3, Grubbs Succo.,
Per Map S-126 OM Sec/38 (17-13) Lying W. of Line Avenue,
Less Twisted Root Commercial Subdivision,
Geo. 71338017006000, Shreveport, Caddo Parish, Louisiana

1931 Enterprises, LLC Mr. Jay Mitchell 4847 Line Avenue Shreveport, LA 71106 T 318-865-5658

APPLICANT: COE Architecture International

Mr. Christopher W. Coe, FAIA 940 College Street Shreveport, LA 71104 T 318-507-7266

NEW LINE AVENUE RETAIL DEVELOPMENT 8700 BLOCK OF LINE AVENUE SHREVEPORT, LA 71106


REVISIONS	
MPC SUBMISSION - 7/9/2024	

SHREVEPORT MPC SITE PLAN APPLICATION

ALL DESIGNS MOICATED IN THESE DRAWNGS ARE THE PROPERTY OF COE ARCHITECTURE INTERNATIONAL CORP. ALL COPYRIGHTS RESERVED. NO COPIST TRANSISSISSIONS REPRODUCTIONS OR ELECTRONIC UMBRULATION OF MY PORTION OF THESE DRAWNGS IN WHOLE OR IN PART AGET TO BE LADS WITHOUT THE DEPRESS WRITTEN PERMISSION OF COE ARCHITECTURE INTERNATIONAL CORP.

MPC SIGNATURE + DATE:

SHEET ISSUE DATE: JULY 9, 2024

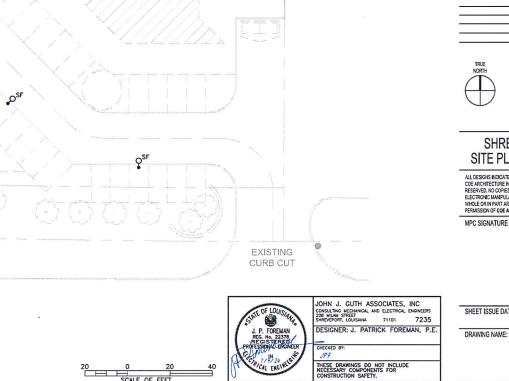

FUTURE BLDG

8700 block of Line Avenue, specifically A Tract of land consisting of a part of Lot 3, Grubbs Succn. Per Map S-126 OM Sec/38 (17-13) Lying W. of Line Avenue

Less Twisted Root Commercial Subdivision. Geo. 71338017006000, Shreveport, Caddo Parish, Louisian

1931 Enterorises LLC Mr. Jay Mitchell 4847 Line Avenue Shreveport, LA 71106 T 318-865-5658

APPLICANT. COE Architecture International

Mr. Christopher W. Coe, FAL 940 College Street T 318-507-7266

> NEW LINE AVENUE RETAIL DEVELOPMENT 8700 BLOCK OF LINE AVENUE SHREVEPORT, LA 71106

REVISIONS



SHREVEPORT MPC SITE PLAN APPLICATION

ALL DESIGNS INDICATED IN THESE DRAWINGS ARE THE PROPERTY ELECTRONIC MANIPULATION OF ANY PORTION OF THESE DRA WHOLE OR IN PART ARE TO BE MADE WITHOUT THE EXPRESS WRITTEN PERMISSION OF COE ARCHITECTURE INTERNATIONAL CORP.


MPC SIGNATURE + DATE:

JOHN J. GUTH ASSOCIATES, INC 7235 71101

JULY 9 2024

DRAWING NAME

© COE ARCHITECTURE INTERNATIONAL CORP

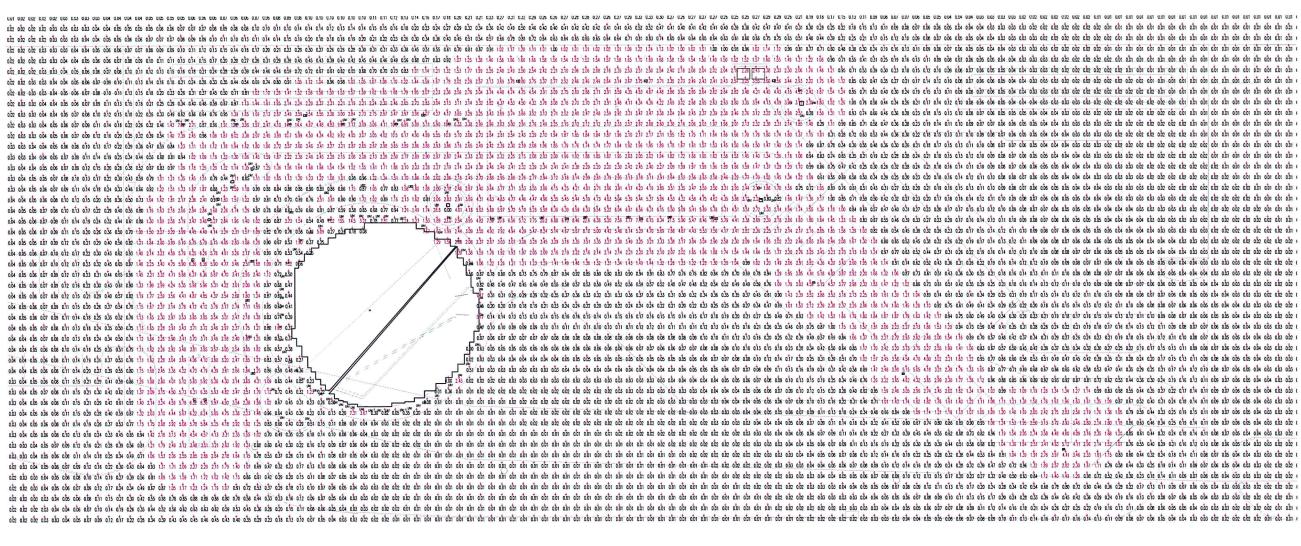

SITE PLAN


EXECUTIVE


DXF file created by LitePro 2.030 on 7/8/2024 3:08:43 PI

TYP	SYMBOL	TOESCRIPTION	LAMP			LUMENS	MOUNTING/BALLAST	IШF	I QTY
LA1		BEGA 77520_BEGA_IES 77520 K4 Copyright LUMCat V	(1) LED	56,2W		7881		1.00	13
LAS	0	American Electr ATBM P05 R3 XXX VR 3K ATBM P05 Package 3000K Roadway	Applic			12583		1.00	3
LB01	0	BEGA 77221_BEGA_IES 77221 Converted by LUMCat V	(1) LED	7,8W	643 lm	645		1.00	12
LBD2		77263 Converted by LUMCat V	(1) LED	2,1W	131 lm	132		1.00	8
LFA1		Hydrel Aspen P1 80CR1 40K 120 550EG FI Aspen, Clear Lens	(1)			685		1.00	91

area name	1/0	DIMENSIONS	LUMS / <asms></asms>	WATTS / SQ FT	QTY
rev parking	out	1120.20x275.50Ft	LA1 (13) LA5 (3) LBD1 (12) LBD2 (8)	0.01	1


8-20-24 a.a.

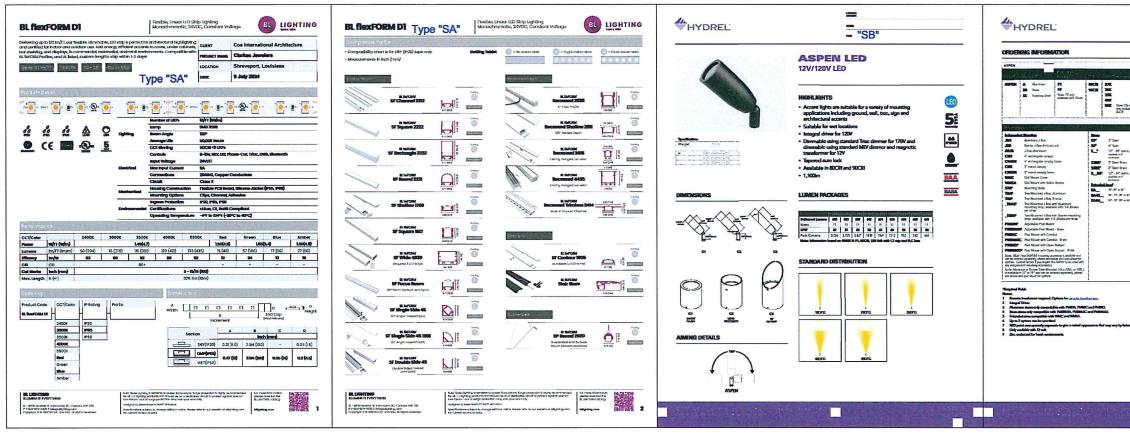

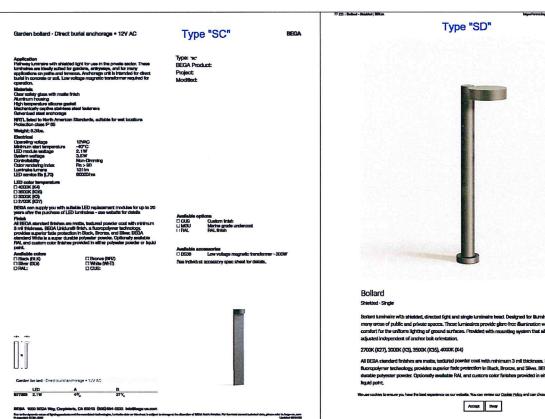





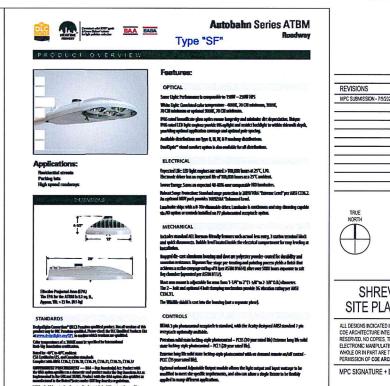

П

SHREVEPORT MPC SITE PLAN APPLICATION ALL DESIGNS INDICATED IN THESE DRAWINGS ARE THE PROPERTY OF COE ARCHITECTURE IN THESE DOWN OF ALL COPYRIGHTS
RESERVED, NO COPIES, TRANSMISSIONS, REPRODUCTIONS OR
ELECTRONIC MANIPULATION OF ANY PORTION OF THESE DRAWNINGS IN
WHOLE OR IN PART ARE TO BE MADE WITHOUT THE EXPRESS WRITTEN
PERMISSION OF COE ARCHITECTURE INTERNATIONAL CORP. MPC SIGNATURE + DATE: AEL Bush JOHN J. GUTH ASSOCIATES, INC CONSULTING MECHANICAL AND ELECTRICAL ENGINEERS 208 MILAN STREET SHEEVEPORT, LOUISIANA 71101 7235

TYPE "SB"

Bill. Braycone
Bill. Comer
Local Comer
Loc

EXAMPLE ASPEN SS P1 BOCKS 30K 12 20DEG WSL KM C1 BL

BL Scale Parameter Statement of the Control of the

TOT 1794: \$10000 17 \$20000 47 \$14.0 Fe Cler TOP 72004: \$10000 77 \$40000 67 \$15.0 National 50 \$2000 77 \$15.0 National 50 \$20000 77 \$20000 10 \$2000

DIRECTOR

APPROVAL



DESIGNER: J. PATRICK FOREMAN, P.E. HESE DRAWINGS DO NOT INCLUD IECESSARY COMPONENTS FOR CONSTRUCTION SAFETY.

SHEET ISSUE DATE: JULY 9, 2024

DRAWING NAME:

COE ARCHITECTURE

A Tract of land consisting of a part of Lot 3, Grubbs Succn., Per Map S-126 OM Sec/38 (17-13) Lying W. of Line Avenue,

NEW LINE AVENUE
RETAIL DEVELOPMENT
8700 BLOCK OF LINE AVENUE
SHREVEPORT, LA 71106

PROPERTY.

OWNER:

1931 Enterprises, LLC

Mr. Jay Mitchell

APPLICANT:

4847 Line Avenue

Shreveport, LA 71106 T 318-865-5658

940 College Street Shreveport, LA 71104

T 318-507-7266

COE Architecture International

Mr. Christopher W. Coe, FAIA

8700 block of Line Avenue, specifically:

Less Twisted Root Commercial Subdivision Geo. 71338017006000. Shreveport. Caddo Parish, Louisiana