

- IRRIGATION CONTRACTOR TO LOCATE AND PROTECT ALL UNDERGROUND UTILITIES PRIOR TO DIGGING.
- ALL VALVES TO BE LOCATED IN VALVE BOX, WITH COVER AT GRADE. LOCATE BOX IN GRASS AREA WHEN POSSIBLE.
- 3. IRRIGATION CONTROLS IN LANDSCAPED AREAS ARE TO BE ENCLOSED IN A 2X2 CONCRETE PAD.
- AUTOMATIC CONTROLLER TO BE MOUNTED IN UTILITY ROOM OR AS DETERMINED BY THE PROJECT MANAGER; SEE ARCHITECTURAL PLANS.
- 5. WEATHER SENSOR (IF REQUIRED) TO BE LOCATED ALONG PARAPET OR AS DETERMINED BY THE PROJECT MANAGER; SEE ARCHITECTURAL PLANS, ENSURE SENSOR IS FREE FROM ANY OBSTRUCTIONS.
- 6. 60 PSI REQUIRED PER ROTOR STATION 40 PSI REQUIRED PER SPRAY STATION - 40 PSI REQUIRED PER ORIP STATION, ALL SPRAY AND ROTOR BODIES TO HAVE PRS (IN-STEM PRESSURE REGULATION SYSTEM) AS INDICATED IN THE LEGEND, FLOW ADJUSTMENTS CAN BE MADE AT THE ZONE'S VALVE TO COMPENSATE FOR THIS

- 7. PRESSURE REGULATOR REQUIRED IF STATIC WATER PRESSURE
- 8. 4* 6* SCH LO PVC SLEEVES ARE TO BE LOCATED AS SHOWN ON SHEET L.2.1. EXTEND SLEEVE IB* BEYOND BACK OF CURB OR PAVENENT. SLEEVES TO BE LOCATED AND EXPOSED BY THE GENERAL CONTRACTOR PRIOR TO START OF THE IRRIGATION INSTALLATION.
- ALL SHRUB BEDS ARE TO BE IRRIGATED USING DRIPLINE UNLESS OTHERWISE NOTED. 4" POP-UP HEIGHT FOR TURE ZONE ROTORS AND SPRAYS, ROTOR NOZZLE SIZE AS INDICATED ON THE IRRIGATION PLAN.
- IO. ALL PIPES, AUTOMATIC VALVES, BACKFLOW PREVENTER, MANUAL VALVE AND METER TO BE LOCATED WITHIN PROPERTY LINES UNLESS OTHERWISS SHOWN. PIPES, VALVES, ETC. SHOWN IN COUNTY.CITY,STATE R.O.W MAY REQUIRE MAINTENANCE AGREEMENT OR INDEMNITY AGREEMENT.
- IRRIGATION METER AND BACKFLOW PREVENTER TO BE PROVIDED BY THE GENERAL CONTRACTOR.
- 12. BACKFLOW PREVENTER TO BE AS PER LOCAL CODE.

- I3. MAINLINE & ALL LATERAL LINES ARE TO BE LOCATED A MINIMUM OF 3' OFF BACK OF CURB/SIDEWALK. ANY SPRAYS OR ROTORS LOCATED IN THIS AREA ARE TO BE CONNECTED USING A FLEXIBLE SWING FIPE (RAINBING SPX-FLEX-100).
- 14. ALL MAINLINES TO HAVE A MINIMUM OF 18" COVER (SCH. 40).
- ALL LATERALS AND SUB-MAIN PIPE TO HAVE A MINIMUM OF 12° (SCH. 40).
- 16. NO ROCKS, BOULDERS, OR OTHER EXTRANEOUS MATERIALS TO BE USED IN BACKFILLING TRENCHES.
- ALL LINES TO BE THOROUGHLY FLUSHED BEFORE INSTALLATION OF SPRINKLER HEADS.
- MUST USE PRODUCTS SPECIFIED ON THIS DRAWING, UNLESS OTHERWISE APPROVED.
- 20. IRRIGATION CONTRACTOR SHALL PROVIDE AN AS-BUILT DRAWING TO THE ARCHITECT.
- IRRIGATION CONTRACTOR TO FIELD VERIFY THAT INSTALLED IRRIGATION SYSTEM PROVIDES 100% COVERAGE UPON COMPLETION OF INSTALLATION. IF SYSTEM DOES NOT PROVIDE 100% COVERAGE THE IRRIGATION CONTRACTOR SHALL REVISE SYSTEM TO PROVIDE 100% COVERAGE PRIOR TO CERTIFICATE OF OCCUPRACY.
- 22. ALL PIPE, VALVES, DRIP, SPRAY HEADS, ROTORS, CONTROLLERS, AND WEATHER SENSORS ARE TO BE INSTALLED AS PER RAINBIRD SPECIFICATIONS. FOR ANY QUESTIONS ON RAINBIRD PRODUCTS OR INSTALLATION CALL BEN KNICKEL AT 678.644.3249
- WATER SOURCE TO BUILDING SHALL BE A 1.5° PVC WITH I° OR 1.5° METER. MAINLINE TO BE 1.5°.
- 24. IF POP UP HEAD IS LOCATED IN SHRUB AREA, CONTRACTOR SHALL ENSURE PROPER HEIGHT OF POP UP TO PROVIDE ADEQUATE WATER COVERAGE.

PLANT LEGEND				
Plant		Quantity	Scheduled Size	
CRAPE MYRTLE	0	7	3° CAL.	
LOBLOLLY PINE		5		
DRUMMOND RED MAPPLE	*	22		
SWEET GUM	0	5		
RED MAPLE	£	6		
EASTERN REDBUD	掌	14		
SOD		10		
BRADFORD PEAR	(·)	10		



LANDSCAPING PLAN

Caddo Electrical Contracting, L.L.C.

Caddo Parish, Louisiana



RALEY AND associates, inc

Civil & Structural Engineering,

Surveying, Planning & Consulting

4913 Shed Road Bossier City, LA 71111

Phone 318.752-9023 Fax 318.752-9025 www.raleyandassociates.com


05/09/2024




DATE:	02/15/2024
SCALE:	1" = 30
DRAWN:	ND
CHECKED	: Mi
JOB:	22443
SHEET:	11

9 SHEETS


OF

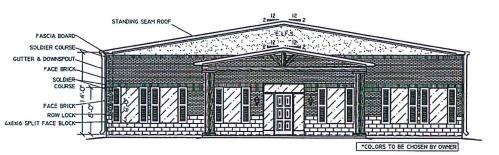


FRONT ELEVATION SCALE: 1/5" = 1'-0"

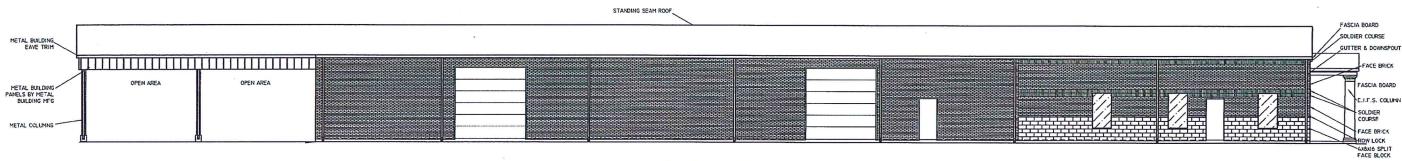

LEFT ELEVATION SCALE: 1'-0"

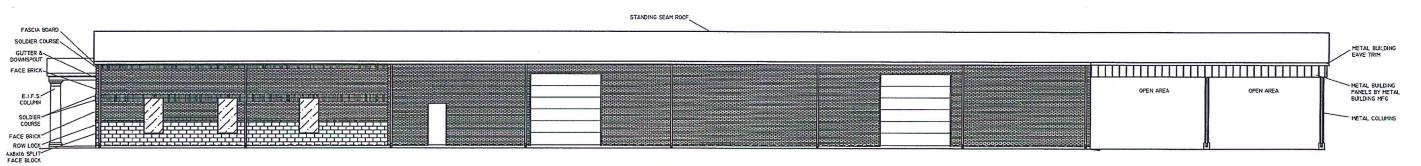

RIGHT ELEVATION SCALE: 18" = 1'-0"

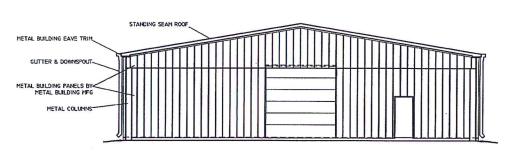

REAR ELEVATION
SCALE: 1'-0"


EXECUTIVE DIRECTOR APPROVAL

EVISIONS	BY
	1

ပ ELEVATIONS

Caddo Electrical Contracting,

Caddo Parish, Louisiana

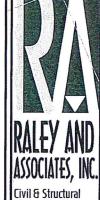

Engineering, Surveying, Planning & Consulting

4913 Shed Road Bossier City, LA 71111

Phone 318.752-9023 Fax 318.752-9025 www.raleyandassociates.com

	Δ3
SHEET:	
JOB:	22443
CHECKE	D: MK
DRAWN:	ECP
SCALE:	3/8" = 1'-0"
DATE:	02/15/2024

OF 9 SHEETS