



DRIP SYSTEM DETAIL VALVE -BACKFLOW PREVENTER -PRESSURE REGULATOR **EXECUTIVE** _TUBING ADAPTER DIRECTOR - DRIP TUBING APPROVAL 18" MINIMUM -BETWEEN EMITTERS -EMITTERS END CAP N.T.S.

PLANTING SCHEDULE

Quantity	Symbol	Scientific Name Common Name		Size Required	
1	8	Juglans regia	English Walnut	Existing	
1 🔅		Pinus palustris	Longleaf pine	Existing	
4	0	Quercus alba	White Oak	Existing	
2	83	Carya illinoinensis	va iilinoinensis Pecan		
7	*	Ulmus americana	Elm, American	7-Gal., 5' Min. Ht.	
4	9	Crataegus opaca	Hawthern, Mayhaw	7-Gal., 5' Min. Ht.	
26	3	Buxus sempervirens	Boxwood	3-Gal., 18" Min. Ht	
8	€ liex opaca Ho		Holly, American	American 3-Gal., 18" Min. H	
As needed	+ + + +	Cynodon dactylon '419'	Class 'A' 419 Bermuda Sod	SY. Squares/Rolls	
2604± SF		N/A	Pine Straw Mulch	SF	
0± LF	~	N/A	Steel Edge, Color; Brown	LF	
0.50± Ac. N/A		DISTURBED AREAS	Bermuda Seed or Equal	Acre	

** Note: For Planting Installation, See Landscaping Details on sheet 2.

	IRRIGATION LEGEND
	SUBJECT PROPERTY LINE
	PROPOSED 1" SCH 40 PVC PIPE (IRRIGATION LINE 18" BELOW F.G.)
	DRIP TUBE
×	PRESSURE COMPENSATING EMITTER
A	CHECK VALVE ON DRIP TUBE

Landscaping Notes:

Large species trees shall be planted in the required landscaped area containing one two-inch caliper tree per 30 linear feet along the front property line(s).

Existing trees, determined by a landscope architect licensed in the State of Louisiana to be in good health, of three—inch caliper or more within the required landscape area, but not located within a utility easement, may be counted as two required street trees; provided that grading and/or pavement does not encroach into the critical root zone of the preserved tree(s).

Tree protection fencing shall be required for all preserved trees during construction.

Required Internal Landscape area = 25 sf/parking space (25x21=525 sf required, 2048

All parking lots shall be screened from the public right—of—way with a continuous

Parking lots shall contain one two-inch caliper shade tree located within a tree island for every 12 parking spaces (2 required, 3 provided).

Tree islands shall have a minimum width of eight feet and a minimum area of 150 square feet.

The maximum allowed grouping of street trees may be up to 25 percent of the required number of street trees. $\label{eq:controller}$

All landscaped areas shall be protected from vehicular encroachment by concrete curbs, wheel stops, or other permanent barriers, and should be raised.

CHRIST BAPTIST SHREVEPORT LANDSCAPING PLAN 8 ОП NORTH TEMPLE C 2142 PINE HILL F

LA 71107

CHURCH



	COSCIL ENGINE				
revisions					
no.	date:				
_					

job no. 2824 drawing name : 2824LandscapingPlan scale : as shown date: 2-16-2018 drawn by: TRB checked by: RBN

SHEET

of 2 SHEETS

NORTH 142 7

DAL AND SURVEY SYNTICES LALC GINEERS — LAND SURVEY ORTH MARKET STREET ORT, LOUISIANA 71107 985 (FAX) 318-673-

BL SENSHIP

evisions no. date:

checked by: RBN

1.1 GENERAL

- 1. Certification of grass seed/sod from seed/sod vendor for each seed mixture, or for sod. 2. List of clant suppliers and anticipated delivery dates.
- 3. Provide sample or product date of planting mix, topsoil, fertilizers, per-emergent and muich or any other amendment required for project.
- B. Quality Assurance: Provide trees, shrubs, ground covers, and plants of quality, size, genus, species, and variety indicated, complying with applicable requirements of ANSI Z60.1 "American Standard for Nursery Stock." Materials that do not meet the afore mentioned requirements may
- C.Special Warranty: Warrant trees, shrubs and ground covers for a period of one year after date of Substantial Completion, against defects including death and unsatisfactory growth, except for defects resulting from lack of adequate maintenance, neglect, or abuse by Owner, abnormal weather conditions unessal for warranty period, or includents which are beyond Contractor's control.
- 1. Remove and replace any unhealthy and dead trees and shrubs within the warranty period.
- D. Maintain and establish lawns by watering, fertilizing, weeding, mowing, trimming, replanting, and other operations to produce a uniformly smooth lawn for not less than the following:
- 1, Sodded Lawns; 30 days after date of Substantial Completion

1.2 PRODUCTS

- A. Trees and Shrubs: Well-shaped, fully branched, healthy, vigorous nursery-grown stock of sizes and grades indicated, free of disease, insects, eggs larvae, and defects, conforming to ANSI Z60.1.
- Provide balled and burtapped trees and shrubs (as per plan), or
 Provide container grown trees and shrubs (as per plan).
- B. Ground Covers and Plants: Established and well rooted in removable containers or integral peat pols and with not less than the minimum numbe and length of numers required by ANSI 260, 1 for the pot size indicated.
- C.Sod: Cortified turt-grass sod complying with ASPA specifications for machine-cut thickness, size, strength, moisture content, and moved height, and free of weeds and undestrable native grasses. Provide viable sod of uniform density, color, and texture, strongly rooted, and capable of vigorous
- Species: Provide sod of grass and species and varieties, proportions by weight, and minimum percentages of purity, germination, and maximum percentage of weed seed as per plan.
- D.Planting mix: ASTM D 5268, pH range of 5.5 to 7, 4 percent organic material minimum, tree of stones 1 inch (25 mm) or targer in any dimension, and other extraneous materials harmful to plant growth.
- 1. Planting mix: Equal parts of sharp sand, peat moss and composted bark.
- E.Lime: ASTM C 602, Class T, agricultural limestone. Add 1,000 2,000 lbs/acre as required according to soil sample.
- F. Peat Humus: Finely divided or granular texture, with a pH range of 6 to 7.5 composed of partially decomposed moss peat (other than sphagnum),
- G. Sawdust or Ground-Bark Humaus: Decomposed, nitrogen-treated, of uniform texture, free of chips, stones, sticks, soil, or toxic materials.
- H.Bone meal: Commercial, raw, finely ground; minimum of 4 percent nitrogen and 20 percent phosphoric acid. Regulate Ph as needed via soil
- I. Super phosphate: Commercial, phosphate mixture, soluble; minimum of 20 percent available phosphoric acid. Regulate Ptr as needed via soil
- J. Lawn fertilizer: Once lawn is established, apply 1-1-1 commercial grade quick release fertilizer. Apply according to manufacturer's recommendations.
- K.Planting bed fertilizer: Osmacote classic 13-13-13 8 to 9 month longevity or Siera Tabs at planting. Apply in accordance to manufacture's
- L. Pre-emergent Herbickie: FreeHand, Barncade G, Pendulum 2G, or Snapshot. Apply according to manufacturer's recommendations for pre and post planting.
- M.Organic Mulch: Organic mulch, free from deleterious materials and suitable as a top dressing, consisting of ground or shredded bank, wood or bank chips, or pine straw, or shredded hardwood.
- N.River Rock: Clean river rock, free of trash, debris, uniform in size and color. Stone size to be 1*-2" stones and shall be in the tan, grey, and earth tone color family. Discard any stones not consistent with the majority of the supplied stone.
- a. Size Range: 2 inches (51 mm) maximum, 1 inch (26mm) minimum.
- O.Steel Edging: ASTM A 569 (ASTM A 569M), standard painted commercial grade steel edging and accessories, fabricated in sections with loops stamped from or welded to face of sections approximately 30 inches (760 mm) apart to receive stakes. Cuts required to Install edging to be sanded and pathet of match factors (nish.
- a. Edging Size Range: 3/16 inch (4.8 mm) wide by 4 inches (102 mm) deep.

1.3 EXECUTION


- A.Planting Mix Preparation: Before mixing, clean topsoil of roots, plants, sods, Stones, clay lumps, and other extraneous materials harmful to plant growth. Mix soil amendments and fertilizers with topsoil at rates indicated.
- B.Lawn Planting Preparation (Disturbed): Loosen subgrade to a minimum depth of 6 inches (150 mm). Remove stones targer than 1-1/2 inches (38 mm) in any dimension and sticks, roots, rubbish, and other extraneous materials.
- Incorporate topsoil soil mixture into existing soil depth required to meet thickness, grades, and elevations shown, after light roiling and natural settlement. Do not spread if planting soil or subgrade is frozen.
 It ill surface soil to a depth of a tleast 6 inches (150 mm). Apply soil amendments and initial fertilizers and mix thoroughly into top 6 inches (150 mm) of soil. Trim high areas and fill depressions. Till soil to a homogenous mixture of 5ne texture.
- C.Lawn Planting Preparation (Undisturbed): Where lawns are to be planted in areas unattered or undisturbed by excavating, grading or surface soil stripping operations, remove and dispose of existing grass, vegetation, and turf.
- Till surface soil to a depth of at least 6 inches (150 mm). Apply soil amendments and initial fertilizers and mix thoroughly into top 6 inches (150 mm) of soil. Trim high areas and fill in depressions. Till soil to a homogenous mixture of fine texture.
- D. Moisten prepared lawn areas before planting when soil is dry and allow surface to dry before planting.
- E. Ground Cover and Plant Bed Preparation: Loosen subgrade of planting bed areas to a minimum depth of 6 inches (150 mm). Remove stones larger 1-1/2 inches (36 mm) in any dimension and sticks, roots, rubbish, and other extraneous materials.
- Spread planting soil mixture to depth required to meet thickness, grades, and elevation shown, after light rolling and natural settlement. Place
 approximately /3 the thickness of planting soil mixture required. Work into top of loosened subgrade to create a transition layer and then place
 remainder of planting soil mixture.
- F. Excavation for Trees and Shrubs: Excavate pits with vertical sides and with bottom of excavation slightly raised at certier to assist drainage, Excavate approximately 1-122 imes as wide as ball diameter and deep enough to allow placing of root ball on a setting layer of planting soil. Loosen hard subsoil in bottom of excavation.
- G.Planting Trees and Shrubs: Set stock plumb and in center of pit or trench with top of ball raised above adjacent finish grade.
- Place a setting layer of compacted planning soil.
 Cut bursap and wire baskets from tops of balts and partially from sides, but do remove from under balls. Do not use planning stock if ball is 2. Out course into the control before or during planning operation.

 3. Place backfill around ball in layers, tamping to sattle backfill and eliminate voids and air pockets.


 4. Dish and tamp top of backfill to form a 3-inch (75 mm) high mound around the rim of the pit. Do not cover top of root ball with backfill,

- H. Tree and Shrub Pruning: Prune, thin, and shape trees and shrubs according to standard horticultural practice. Prune trees to retain required height and spread. Do not cut tree leaders; remove only injured or dead branches from flowering trees. Prune shrubs to retain natural character. Shrut sites indicated are size after pruning.

- Planting Ground Cover and Plants: Plant spacing according to plan, unless otherwise indicated. Dig holes large enough to allow spreading of roots, and bacfulfi with planting soil. Work soil around roots to elabrinate air pockets and leave a slight soucer indentation around plants to hold water. Water thoroughly after planting, taking care not to cover plant crowns with wet soil.
- J. Planting Bed Fertilizer; Install per manufactures recommendations
- K. Pre-Emergent Herbicide: Install per manufactures recommendations.
- L. Mulching: Completely cover area to be mulched. Apply mulch and finish level with adjacent finish grades. Do not place mulch against trunks or
- 1, Mulch Type and Thickness: Cut pine straw (bags), 4 inches (100 mm) thick as indicated in all bed areas on drawings.
- M.Sodfing Lawns: Lay sod to form a solid mass with tightly fitted joints within 24 hours of stripping. Butt ends and sides of sod; do not streich or overlap. Stagger sod strips or pads to offset joints in adjacent courses. Avoid damage to subgrade or sod during installation. Tamp and roll lightly to ensure countact with subgrade, eliminate at mockets, and form a smooth surface. Work sitted soil or fine sand into minor cracks between pieces of sod; remove excess to avoid smothering sod and adjacent grass.
- Anchor sod on slopes exceeding 1:5 with wood pegs spaced as recommended by sod manufacturer.
 Saturale sod with the water spray within 2 hours of planting. During first week, water daily or more frequently as necessary to maintain mois sold to a minimum depth of 1-1/2 inches (38 mm) below the sod.
- N.Edgings: Install edgings where indicated and anchor with stakes driven below top elevation of edging according manufacturer's recommendations
- O.Disposal: Remove surplus soil and waste material, including excess subsoil, unsultable soil, trash, and debris, and legally dispose of it off the Owner's property.

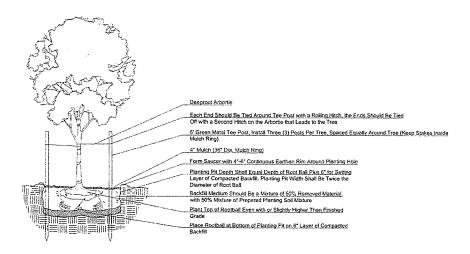

TREE PLANTING DETAIL

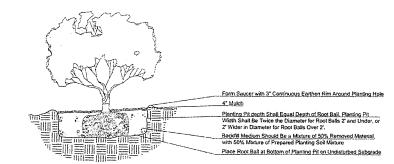

SHRUB PLANTING DETAIL


** UTILITY WARNING **

45 HOURS SEFORE YOU DIG

CALL
CALL
LOUISIANA ONE CALL
(TOLL FREE)
1-600-272-3020

job no. 2824 drawing name : 2824LandscapingPla scale : as shown date: 2-16-2018 drawn by: TRB

SHEET

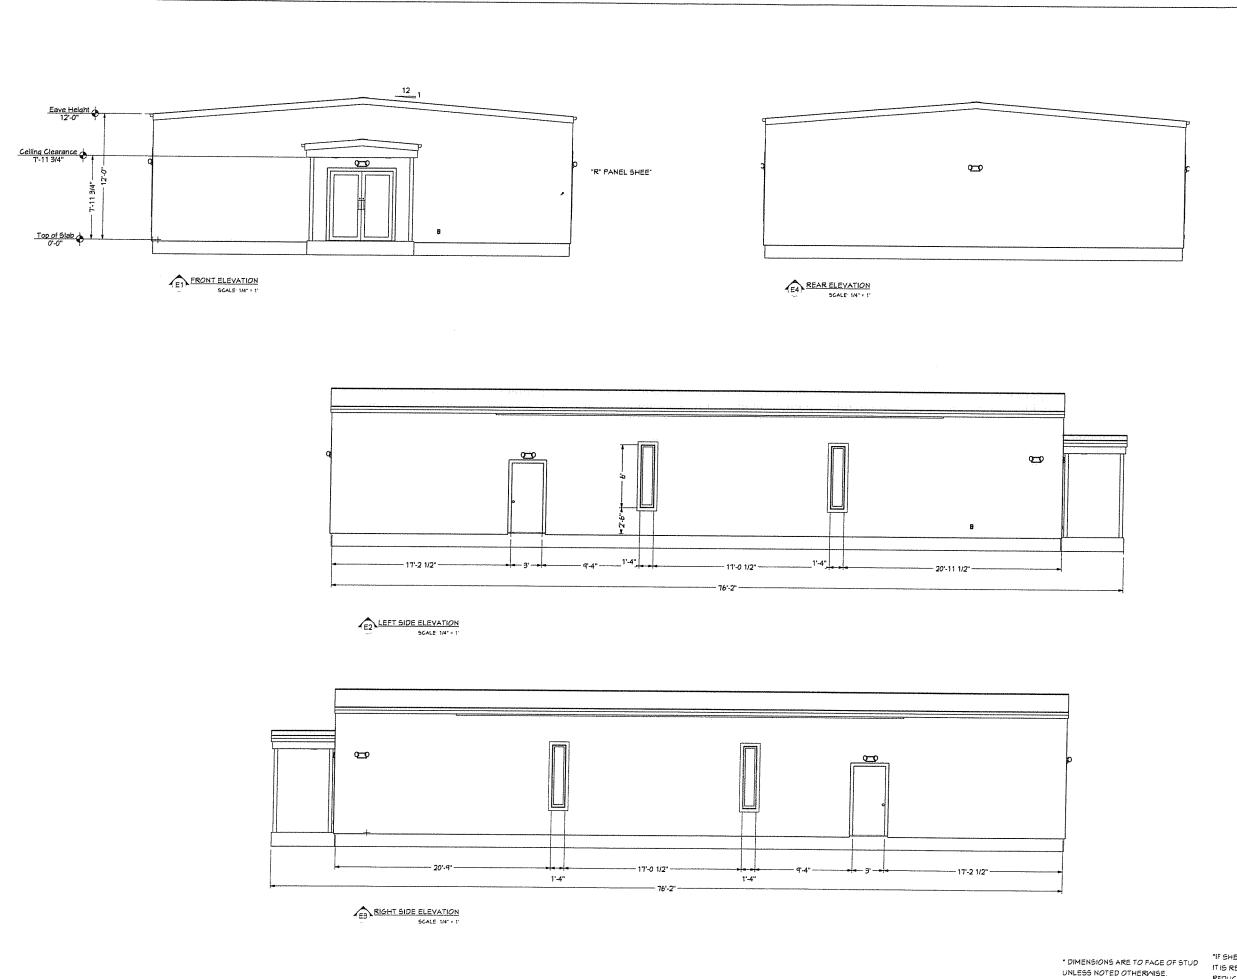

(A Division of North Shreve Enterprises Inc.)
-8581 Shreveport, LA North Shreve

226-8581

318

11/8/2017 Description:

Sheet #

Location: 2143 Pine Hill Rd Shreveport, LA

EXT. ELEVATIONS

Drawn by: Date:

NORTH SHREVE

& CONSTRUCTION

DESCRI MARKATION DELETION

SHOW ADDRESSATION

188 224 4978 In 188 222-9-0-8 EDICH

SHOWN 73 DESTRUCTION

SHOWN 73 DESTRUCTION

SHOWN 75 DESTRUCTION

This document is the property of North Shreve Enterprises Inc.
Any duplication or use other than its intended purpose is prohibited unless authorized by North Shreve Enterprises Inc.


TEMPLE OF CHRIST

Job # A4


5126

*IF SHEET IS LESS THAN 24 X 36 IT IS REDUCED PRINT, SCALE REDUCED ACCORDINGLY.

WINDOW SCHEDULE									
NUMBER	LABEL	QTY	IFLOOR	SIZE	MDTH	HEIGHT	DESCRIPTION		
W01	1460FX	4	1	1460FX	16 "	72 "	FIXED GLASS		

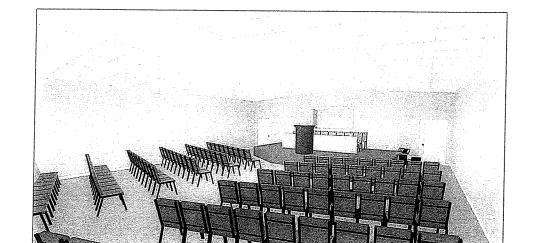

SANCTUARY

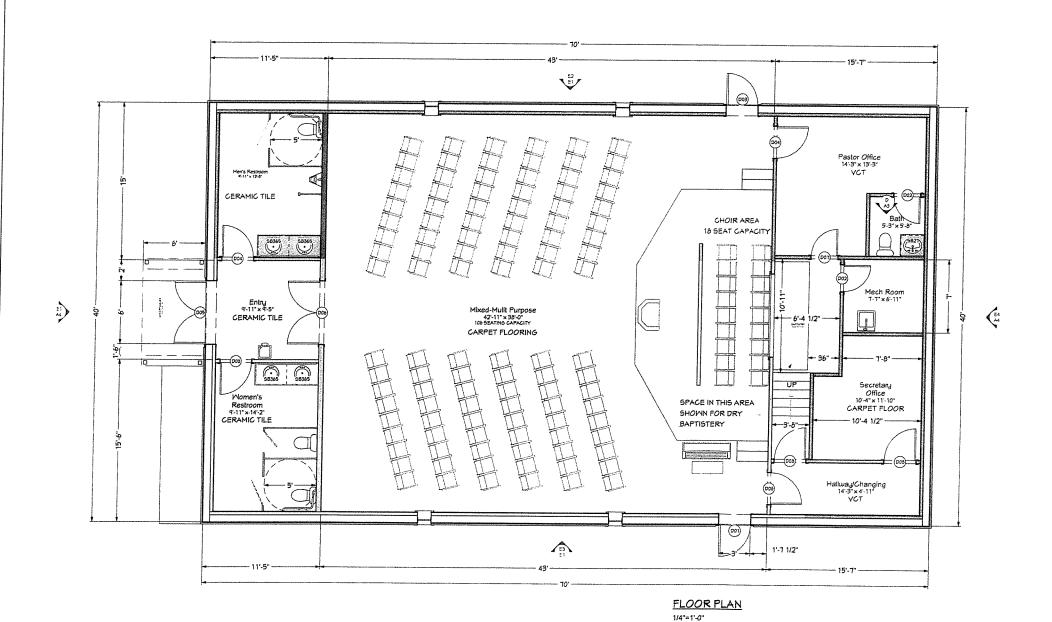

Construction (A Division of North Shreve Enterprises Inc.) Steel North Shreve

Fax 222-3436

Shreveport,

226-8581

318

This document is the property of North Streve Enterprises Inc.
Any duplication or use other than its intended purpose is prahibited unless authorized by North Streve Enterprises Inc.

RTH SHREVE STE

CONSTRUCTION

DESIGN ROBLESIES BESTON

DESIGN ROBLESIES BESTON

DESIGN ROBLESIES BESTON

SEL WAY 7. ROSTIN

SEL

TEMPLE OF CHRIST

Location: 2143 Pine Hill Rd Shreveport, LA

Drawn by: Date: 11/8/2017

Description: FLOOR PLAN

Sheet #

A2

Job # 5126

UNLESS NOTED OTHERWISE.

REDUCED ACCORDINGLY.

DIMENSIONS ARE TO FACE OF STUD IT IS REDUCED PRINT, SCALE *IF SHEET IS LESS THAN 24 X 36