

SITE NAME: LA SHREVEPORT

INTEGRISITE P.O. BOX 786 WEST MONROE, LA 71294

SITE ACQUISITION

CONTACT:

ARCHITECT

YOUNG DESIGN CORP. 10245 E. VIA LINDA, SUITE 211 SCOTTSDALE, AZ, 85258 PHONE: (480) 451-9609 CELL: (619) 892-1051 CONTACT: LUCAS STROBERG SURVEYOR

RILEY COMPANY OF LOUISIANA, INC. 112 EAST MISSISSIPPI AVE. P.O. DRAWER 1303 RUSTON, LOUISIANA 71273 PHONE: (318) 251-0238 FAX: (318) 251-0239 CONTACT: GARLAND D HERRING

LESSOR / OWNER

CLIFFORD MADISON PROPERTIES, LLC

ALTA TOWERS, LLC.

LESSEE / COMPANY

EXECUTIVE

DIRECTOR


**APPROVAL** 

310 MAIN PLAZA - SUITE 381 NEW BRAUNFELS, TX 78130 CELL: 210-237-9426 CONTACT: MELISA HOLLEY

SITE PHOTO:



VICINITY MAP:

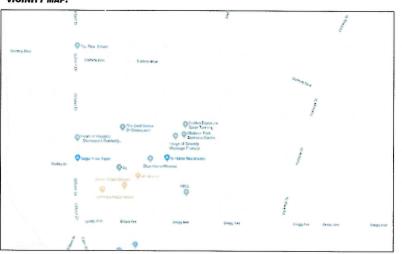

ITE	<b>COORDINATES:</b>	
0 H G Re-	OCCIDINALES.	

LATITUDE LONGITUDE ELEVATION

32° 28' 18.84" -93° 44' 06.92" 164.82' NORTH

**DRIVING DIRECTIONS:** 

ZONING COMPLIANCE:

LOCAL JURISDICTION: ASSESSORS PARCEL: ZONING:

PARENT PARCEL AREA: PROPOSED LEASE AREA: PARKING REQ'D: PARKING PROVIDED: SHREVEPORT, LA

TBD TELECOMM FACILITY 2,500 SQ.FT.

#### **GENERAL COMPLIANCE:**

HVAC USED ON THIS STRUCTURE IS NOT INTENDED FOR HUMAN COMFORT ITS USE IS SOLELY FOR ELECTRONIC EQUIPMENT COOLING.

DEVELOPMENT AND USE OF THIS SITE WILL CONFORM TO ALL APPLICABLE CODES AND ORDINANCES. PROVIDE STREET ADDRESS IDENTIFICATION PER

PROVIDE STREET ADDRESS IDENTIFICATION PER MUNICIPAL REQUIREMENTS.
THE USE OF THIS SITE WILL GENERATE NO TRASH.
THIS PROJECT DOES NOT REQUIRE WATER OR SEWER THIS PROJECT REQUIRES PERMANENT POWER & TELEPHONE CONNECTION

## A.D.A. COMPLIANCE:

FACILITY IS UNMANNED AND NOT FOR HUMAN HABITATION. LANDINGS AND EXITS SHALL COMPLY WITH THE APPLICABLE BUILDING CODE.

### F.C.C. COMPLIANCE:

ALL PROPOSED ANTENNAS SHALL BE IN COMPLIANCE WITH ALL FEDERAL COMMUNICATIONS COMMISSION (FCC) REGULATIONS, INCLUDING THOSE PROTECTING THE PUBLIC HEALTH AND THOSE PROTECTING HISTORIC

### COLLOCATION:

TOWER SHALL BE DESIGNED IN A MANNER THAT WILL ALLOW FOR THE COLLOCATION OF AT LEASE TWO ADDITIONAL ARRAYS ON THE FACILITY

## PROJECT DESCRIPTION:

THE PROJECT CONSISTS OF THE INSTALLATION AND OPERATION OF ANTENNAS AND ASSOCIATED **EQUIPMENT FOR COMPANY'S WIRELESS** TELECOMMUNICATIONS NETWORK, FACILITY IS UNMANNED AND NOT FOR HUMAN HABITATION. THIS FACILITY IS A SITE BUILT TELECOMMUNICATION SITE, TO HOUSE RADIO EQUIPMENT, NO HAZARDOUS MATERIAL WILL BE STORED WITHIN THE FACILITY.

ALL EXITS SHALL BE OPERABLE FROM THE INSIDE WITHOUT THE USE OF KEYS OR SPECIAL KNOWLEDGE. MANUALLY OPERATED EDGE OR SURFACE MOUNTED FLUSH BOLTS ARE PROHIBITED

NEW LESSEE ANTENNAS AND ASSOCIATED COAXIAL CABLES

NEW ELECTRICAL SERVICE NEW WOOD FENCE NEW 95' MONOPINE NEW ELEVATED EQUIPMENT PLATFORMS

NEW CELLULAR ANTENNAS AND ASSOCIATED EQUIPMENT FOR TELECOMMUNICATION COMPANY'S NETWORK COMMUNICATION

and the second	
T1	TITLE SHEET, PROJECT INFO
LS1	LAND SURVEY
A1	SITE PLAN
A2	ENLARGED SITE PLAN
АЗ	ANTENNA INFO / SITE ELEVATION
A4	CONSTRUCTION DETAILS
E1	GENERAL NOTES / LEGEND / SHEET INDEX
E2	SITE POWER PLAN
E3	ENLARGED POWER PLAN
E4	ONE LINE / CALCS
E5	GROUNDING PLANS
E6	GROUNDING DETAILS
L1	LANDSCAPING SHEETS
L2	LANDSCAPING SHEETS





architecture / project management 10245 E. Via Linda, Scottsdale, AZ 85258 ph: 480 451 9609 fax: 480 451 9608

"SEAL
This drawing is copywrited and the property of Young
Design Corporation (YDC) & produced solely by YDC and
affiliates. reproduction or use of this drawing and/or
the information contained hereon is forbidden without
written permission by Young Design Corporation.

1	02/03/2020	PRELIM CDS

-ARCHITECTS JOB NO. -YDC-8981

PROJECT INFORMATION -


LA - SHREVEPORT **CONST. DRAWINGS** 


> 3817 GILBERT AVE SHREVEPORT, LA 71104

TITLE SHEET


-JURISDICTION APPROVAL


SHEET NUMBER

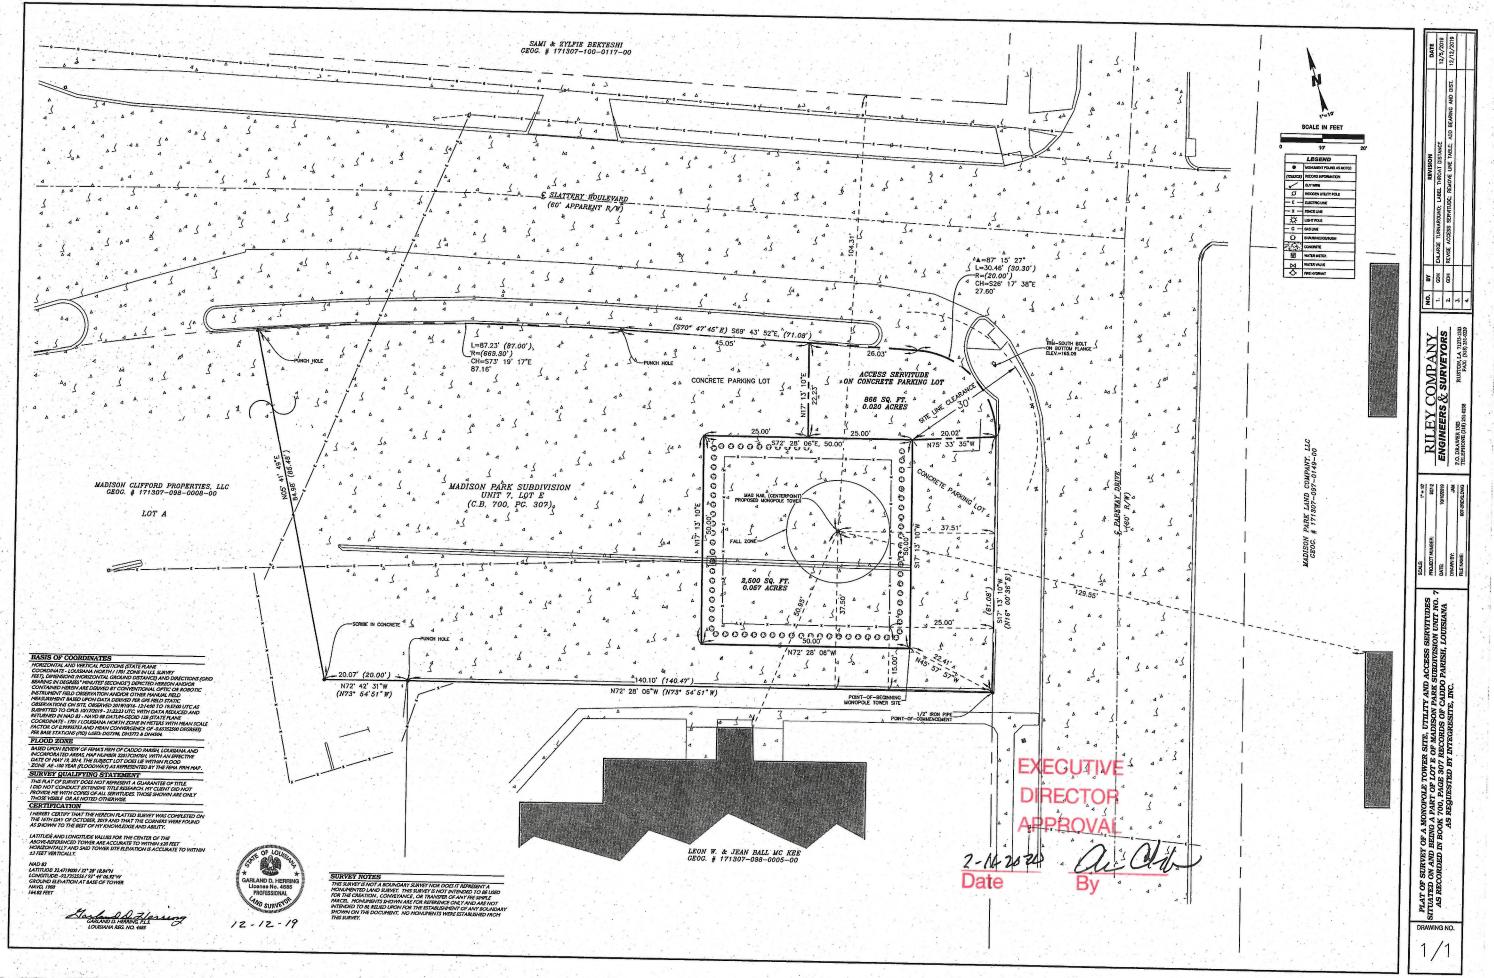


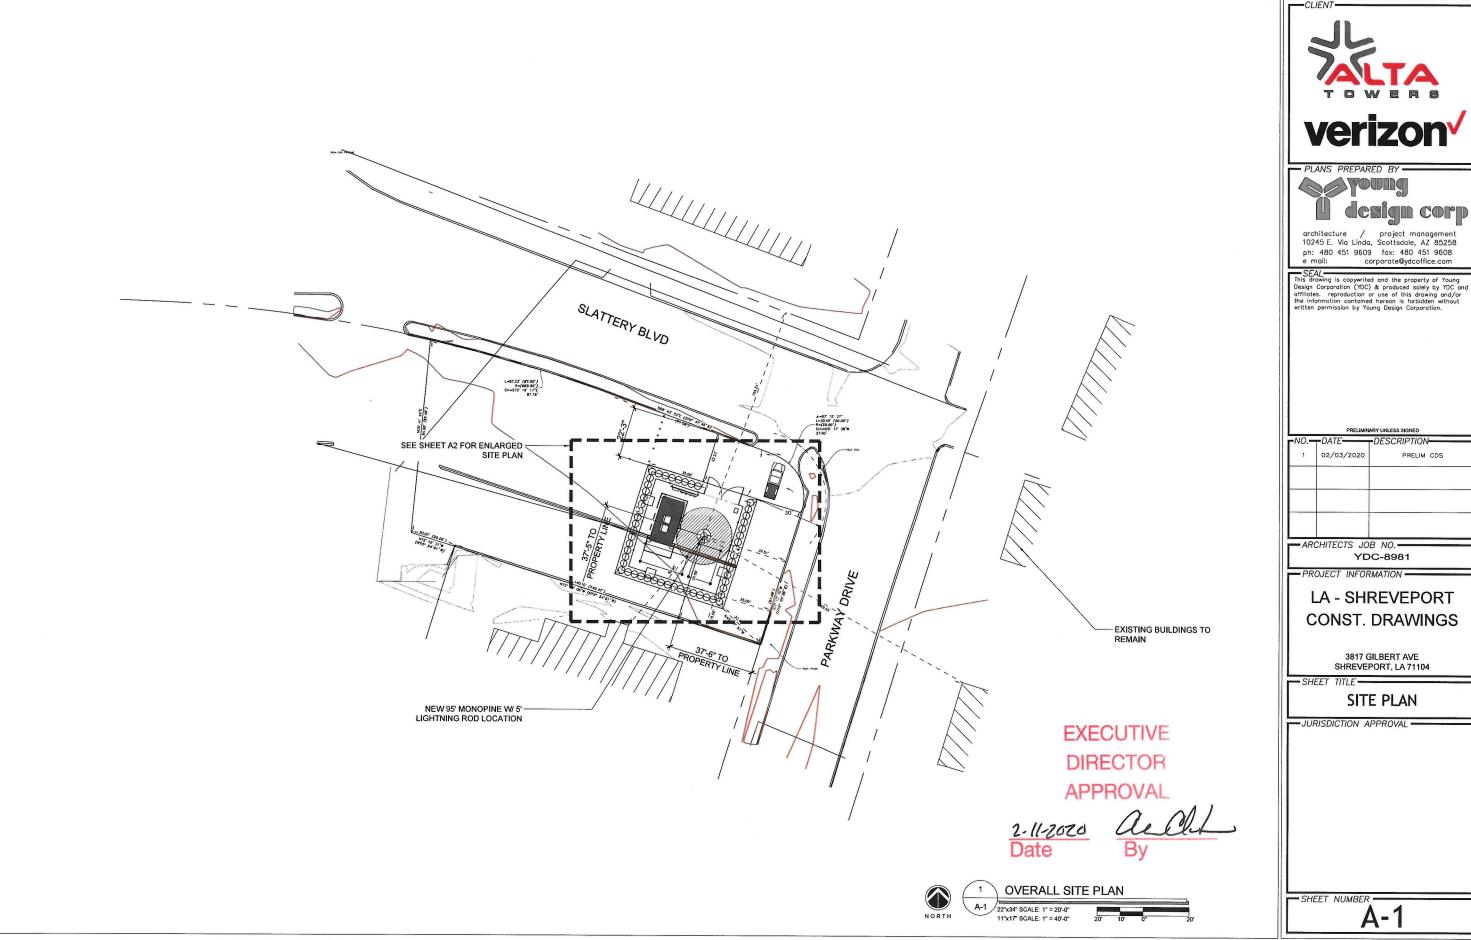

PRELIM CDS

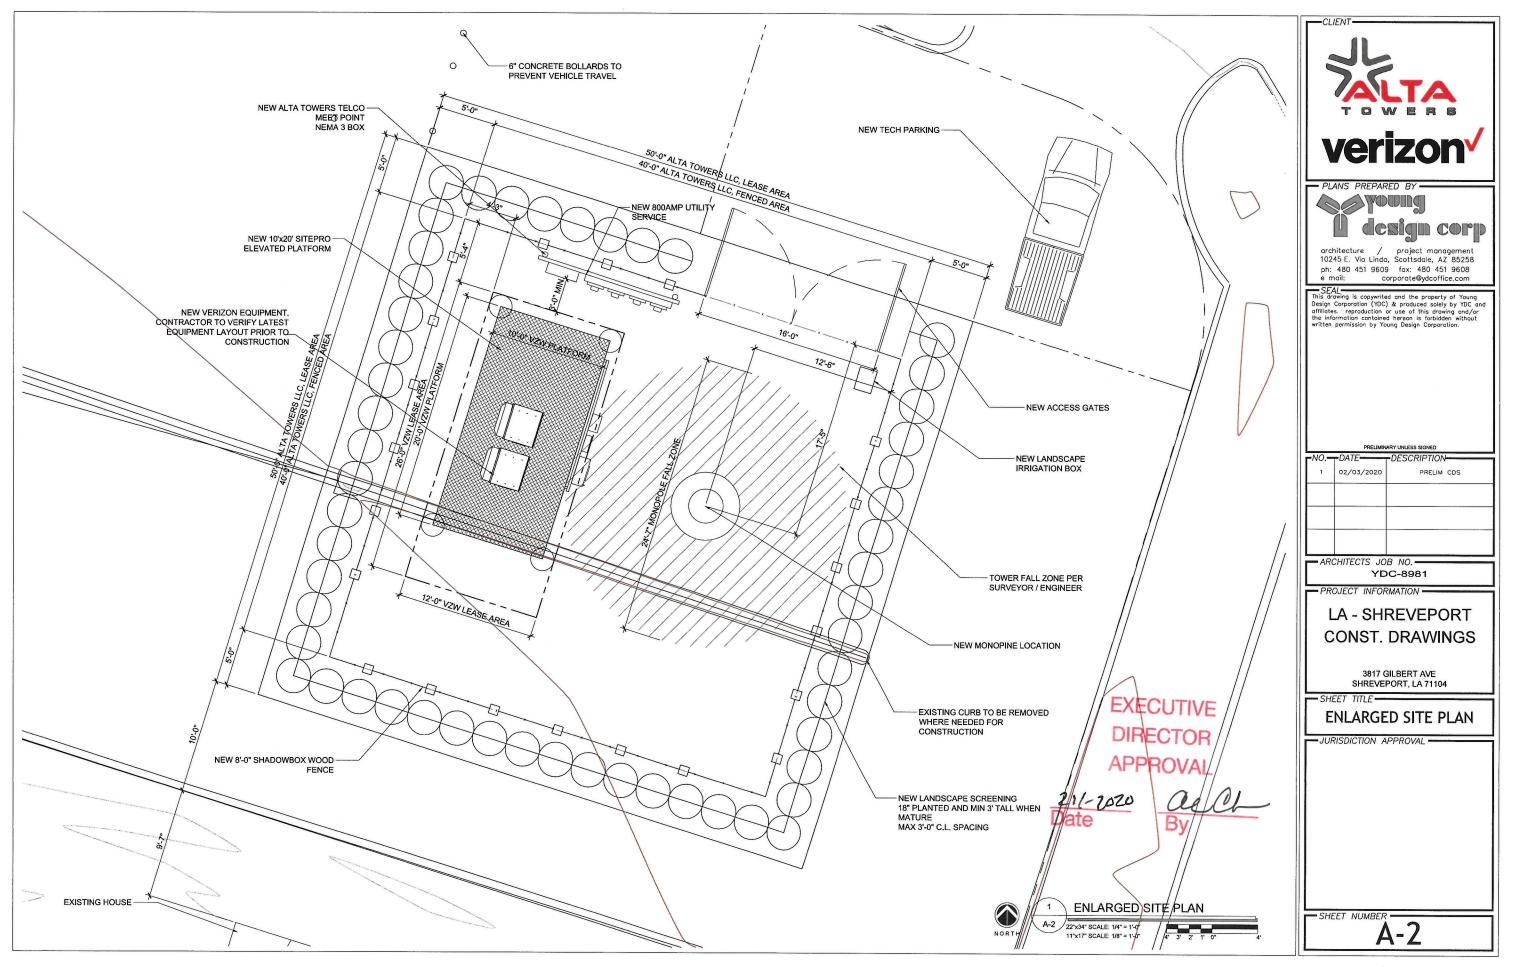

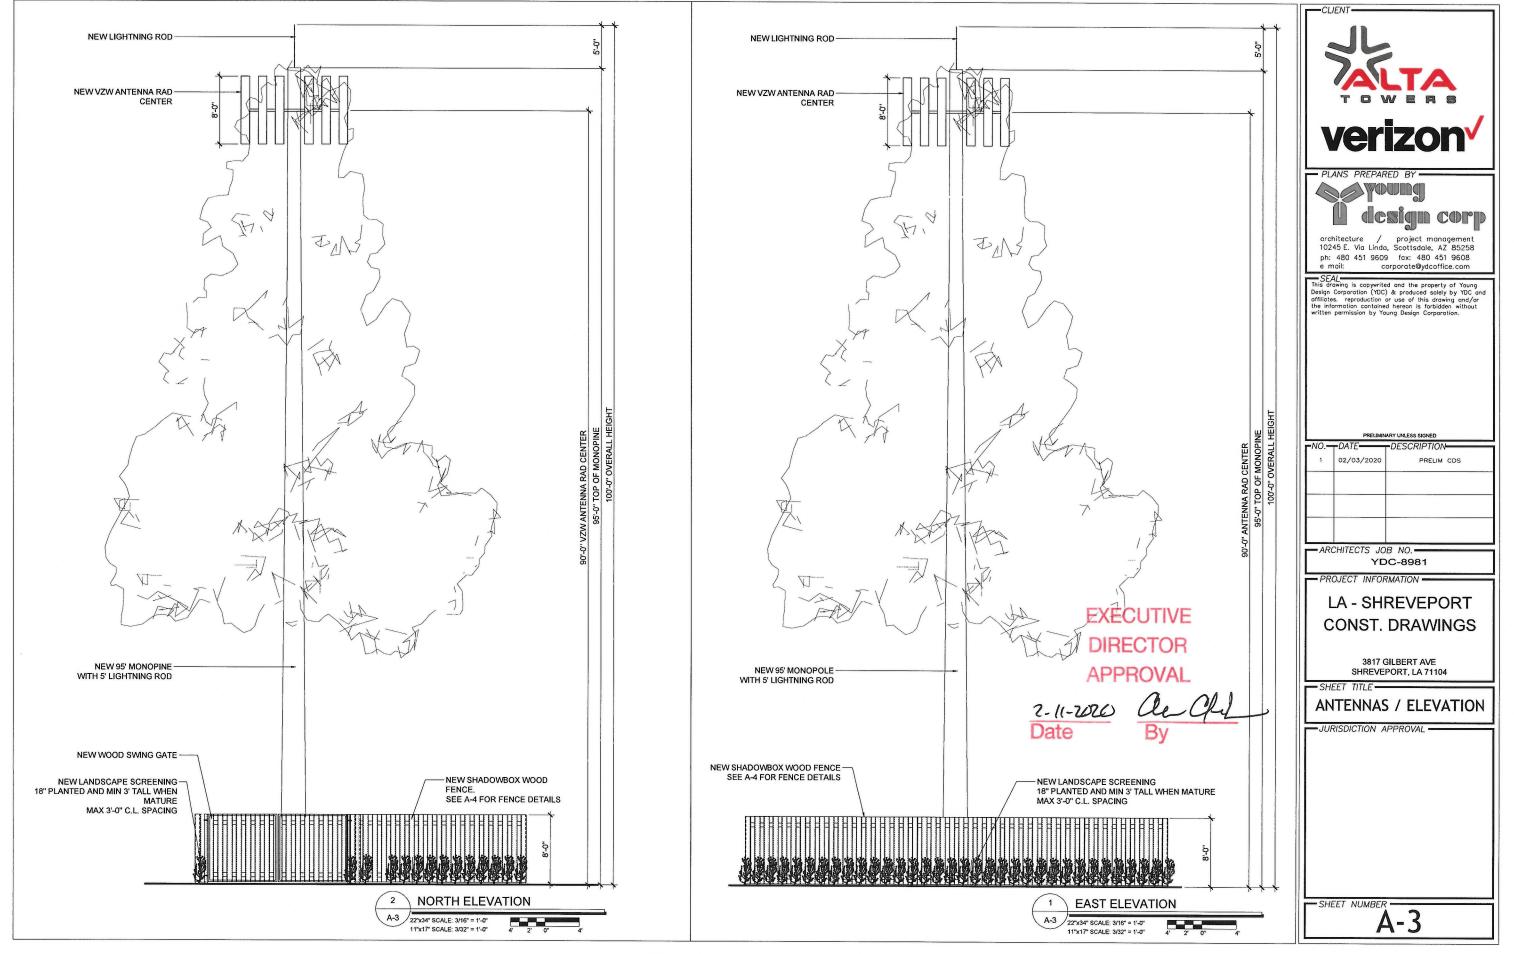

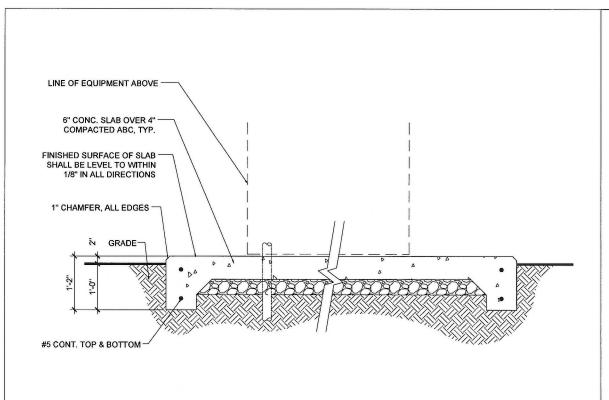

**CONCRETE PAD** 

SHADOWBOX FENCE & POST DETAIL

## **WOOD FENCE NOTES**

5

3

- 1. BOTTOM OF CONCRETE BASE SHALL BE SET BELOW FROST LINE (SEE LOCAL CODE) CONCRETE BASE IS RECOMMENDED MINIMUM AND SHOULD BE REDESIGNED FOR CONDITIONS WHERE SOIL IS POOR
- 1. BOTTOM OF CONCRETE BASE SHALL BE SET BELOW FROST LINE (SEE LOCAL CODE) CONCRETE BASE IS RECOMMENDED MINIMUM AND SHOULD BE REDESIGNED FOR CONDITIONS WHERE SOIL IS POOR. PROVIDE CONCRETE WITH A 28 DAY STRENGTH OF 4000 PSI, (MIN.).

  2. ALL POSTS SHALL BE INSTALLED IN FOOTINGS AS SPECIFIED, WHERE THE POST IS SET IN ROCK OR CONCRETE, CORE A HOLE 12" DEEP AND 1" LARGER IN DIAMETER THAN THE POST. SET THE POST AND GROUT IN PLACE USING NON-SHRINK GROUT.

  3. ALL MATERIAL FOR THE WOOD FENCE SHALL BE PRESSURE-TREATED BY CHROMATED COPPER ABENATE (CCA) PER AMERICAN WOOD PRESERVERS BUREAU (AWPB) STANDARDS. ALL MATERIAL FOR THE WOOD FENCE SHALL BE PRESSURE-TREATED BY CHROMATED COPPER ABENATE (CCA) PER AMERICAN WOOD PRESERVERS BUREAU (AWPB) STANDARDS. ALL MATERIAL FOR THE WOOD FENCE SHALL BE PRESSURE-TREATED TO AWPB STANDARD LP-22 (GROUND CONTACT) AND ALL OTHER MATERIAL SHALL BE TREATED TO AWPB STANDARD LP-22 (GROUND USC), LP-22 TREATED WOOD MAY BE SUBSTITUTED FOR LP-2 TREATED BUT NOT THE REVERSE.

  4. ALL FASTENERS & HARDWARE FOR THE WOOD FENCE SHALL BE HOT DIPPED GALVANIZED.

  5. ALL PIPE SHALL BE SCHEDULE 40.

  6. CONTRACTOR SHALL PROVIDE HOLD OPEN STOPS/DEVICES FOR ALL GATES.


  7. GATES SHALL SWING FREELY AND UNOBSTRUCTED IN THE DIRECTION SHOWN ON THE CONSTRUCTION DRAWMOSK (SEE SHT 0.3) TO THE PULL OPEN POSITION.

  8. ALL WOOD GATES SHALL HAVE PIPE FRAME BRACING (MELDED ASSEMBLY, COLD GALV, AND SILVER PAINT WELD AREASON) ALONG WITH DIAGONAL BRACING (39° DIA. STEEL TRUSS ROD) AS SPECIFIED.

  9. THE GRADE OF THE SITE AND INSTALLATION OF THE FENCE SHALL PROVIDE FOR NO MORE THAN A 1" GAP BETWEEN THE BOTTOM OF THE FENCE MATERIAL AND FINISH GADE.


  10. CANTES SHALL BE MANUFACTURED SUCH THAT THERE EXISTS THE CAPACITY FOR A CHAIN TO BE USED AS THE LOCKING MECHANISM. AND LOCKS TO BE DAISY CHAINED TO PROVIDE MULTIPLE ACCESS TO THE SITE. CONTRACTOR SHALL PROVIDE A 3" SIZE, THREE FOOT (3)! LENGTH OF CHAIN TO BE USED AS THE LOCKING MECHANISM.

  11. CONTRACTOR SHALL PROVIDE A 3" SIZE, THREE FOOT (3)! LENGTH OF CHAIN TO BY GALV, OR VINYL COATE

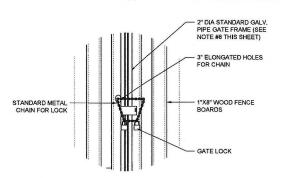

WOOD FENCE GATE DETAIL

FENCE NOTES AND LOCK DETAIL

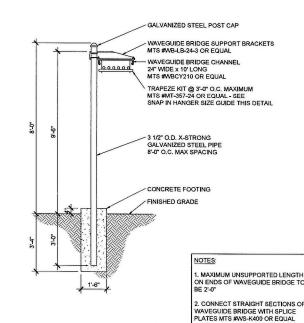

CABLE BRIDGE DETAIL

3. CONNECT ANGLED SECTIONS OF WAVEGUIDE BRIDGE WITH ADJUSTABLE SPLICE MTS #MT-F504 OR EQUAL

2



project manageme 10245 E. Via Linda, Scottsdale, AZ 85258 ph: 480 451 9609 fax: 480 451 9608 corporate@ydcoffice.com

SEAL.

This drawing is copywrited and the property of Young Design Corporation (YDC) & produced solely by YDC and affiliates. reproduction or use of this drawing and/or the information contained herean is forbidden without written permission by Young Design Corporation.



- ARCHITECTS JOB NO YDC-8981

- PROJECT INFORMATION -

LA - SHREVEPORT **CONST. DRAWINGS** 


> 3817 GILBERT AVE SHREVEPORT, LA 71104


**DETAILS** 

-JURISDICTION APPROVAL

SHEET NUMBER

70-79-C

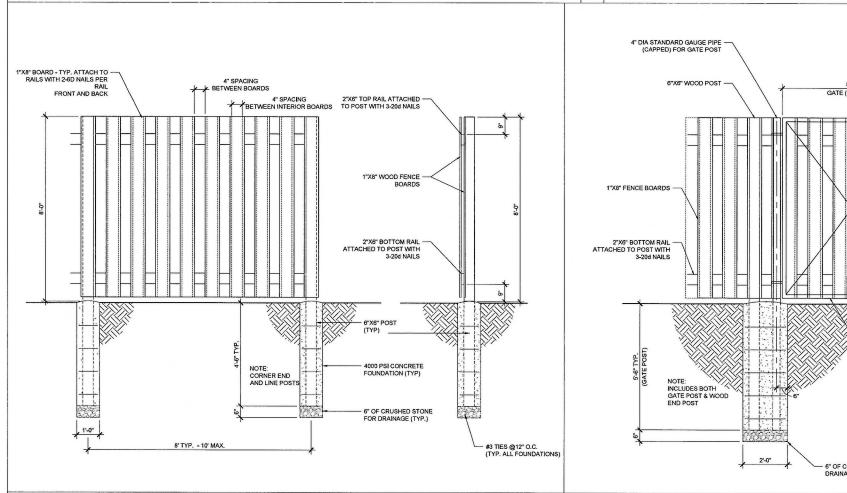


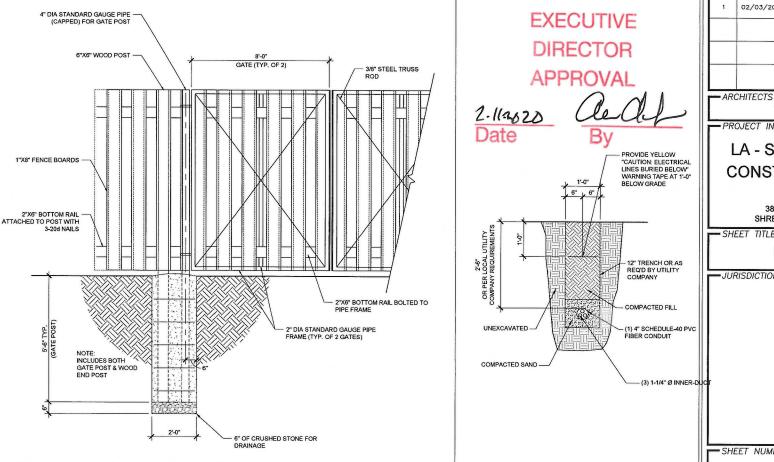


3

FIBER TRENCH DETAIL

4

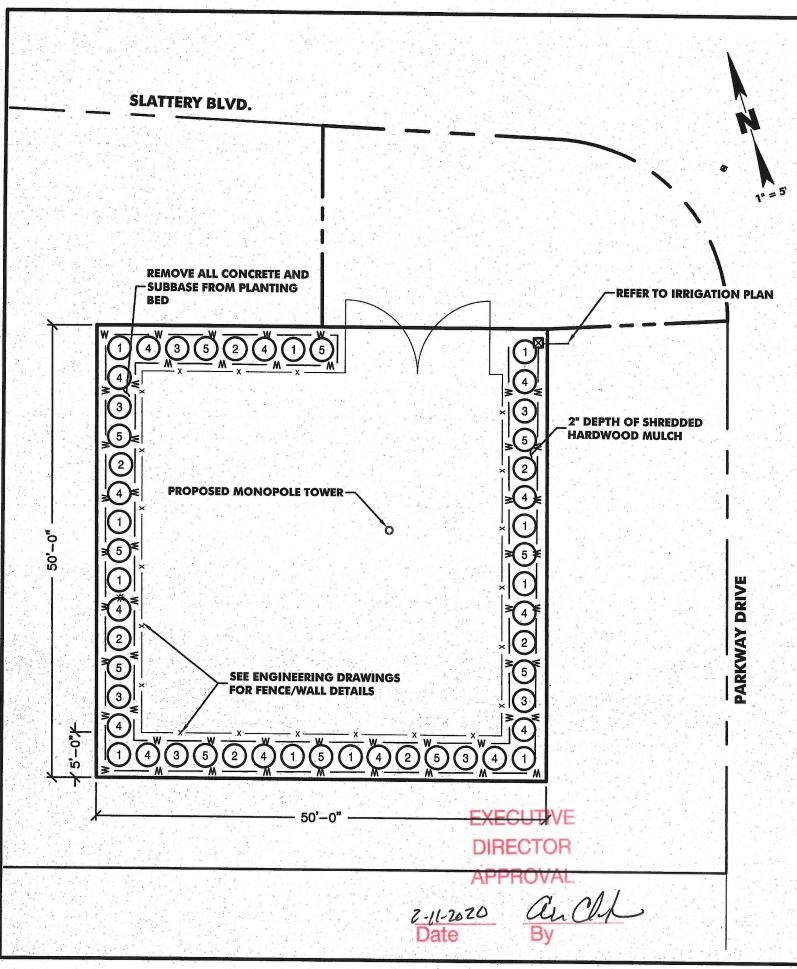

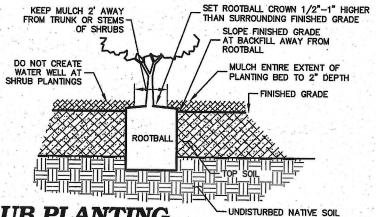

# SHRUB PLANTING

PLANT SCHEDULE						
SHRUBS	COMMON NAME/BOTANICAL NAME	QTY	CONTAINER	MATURE HGT.	MATURE WIDTH	
1	LEANN CLEYERA/CLEYERA JAPONICA	11	3 GAL	8'-10'	4'-6'	
2	INDIAN HAWTHORN/RHAPHIOLEPSIS INDICA	7.	3 GAL	4'-6'	4'-6'	
3	PRIMROSE JASMINE/JASMINUM MESNYU	7	3 GAL	4'-6'	4'-6'	
4	FLORIDA JASMINE/JASMINUM FLORIDUM	14	1 GAL	2'-5'	3'-5'	
(5)	DWARF NANDINA/NANDINA DOMESTICA	11	1 GAL	2'-3'	2'-3'	

# **GENERAL NOTES**

TOTAL

ALL SHRUBS TO BE FULL AND UNIFORM BY SPECIES WITH MATCHING CHARACTER

50

- AND BRANCHING STRUCTURE. EACH PLANT VARIETY MUST COME FROM A SINGLE SOURCE SUPPLIER IN ORDER
- TO MAINTAIN A CONSISTENT APPEARANCE.

  CONTAINER GROWN PLANTS MUST HAVE A WELL ESTABLISHED ROOT SYSTEM REACHING THE SIDES OF THE CONTAINER, ABLE TO MAINTAIN A FIRM BALL WHEN THE CONTAINER IS REMOVED, BUT SHALL NOT HAVE EXCESSIVE ROOT GROWTH ENCIRCLING THE INSIDE OF THE CONTAINER.
- LARGE SHRUBS MUST HAVE A MIN. HEIGHT OF 3' AT INSTALLATION. SMALL SHRUBS MUST HAVE A MINIMUM HEIGHT OF 18" AT INSTALLATION. LARGE SHRUBS ARE THOSE SHRUBS THAT REACH 5' OR MORE IN HEIGHT AT MATURITY. SMALL SHRUBS ARE THOSE SHRUBS THAT MAY GROW UP TO 5' IN HEIGHT IF LEFT UNMAINTAINED, BUT ARE GENERALLY MAINTAINED AT HEIGHTS OF 18"-24".
- 5. ALL PLANT MATERIALS MUST BE OF GOOD QUALITY AND MEET AMERICAN ASSOCIATION OF NURSERYMEN (AAN) STANDARDS FOR MINIMUM ACCEPTABLE FORM, QUALITY, AND SIZE FOR SPECIES SELECTED. SIZE AND DENSITY OF PLANT MATERIAL, BOTH AT THE TIME OF PLANTING AND AT MATURITY, ARE ADDITIONAL
- CRITERIA THAT MUST BE CONSIDERED WHEN SELECTING PLANT MATERIAL.

  6. REMOVE ALL CONCRETE AND SUB BASE FROM THE PLANTING BED AND INSTALL 18" OF TOP SOIL.
- ALL TOPSOIL SHALL BE IN ACCORDANCE WITH DOTD SECTION 715. PLANTING BED SHALL BE TOPPED WITH 2" DEPTH OF SHREDDED HARDWOOD

## CAUTION NOTICE TO CONTRACTOR

THE CONTRACTOR IS SPECIFICALLY CAUTIONED THAT THE LOCATION AND/OR ELEVATION OF EXISTING UTILITIES AS SHOWN ON THESE PLANS ARE BASED ON RECORDS OF THE VARIOUS UTILITY COMPANIES AND, WHERE POSSIBLE, MEASUREMENTS TAKEN IN THE FIELD. THE INFORMATION IS NOT TO BE RELIED ON AS BEING EXACT OR COMPLETE. THE CONTRACTOR MUST CALL "LOUISIANA ONE CALL" BEFORE DIGGING - DIAL 811 OR 800-272-3020 AT LEAST 72 HOURS BEFORE ANY EXCAVATION TO REQUEST EXACT FIELD LOCATION OF UTILITIES. IT SHALL BE THE RESPONSIBILITY OF THE CONTRACTOR TO RELOCATE ALL EXISTING UTILITIES WHICH CONFLICT WITH THE PROPOSED IMPROVEMENTS SHOWN ON THE PLANS.



Alta Towers, LLC

## RILEY COMPANY **ENGINEERS & SURVEYORS**

P.O. DRAWER 1303 TELEPHONE (318) 251-0238 FAX: (318) 251-023

	REVISIONS							
REV	DATE	DESCRIPTION	INITIALS					
1	01/02/20	CONSTRUCTION DOCUMENTS	HRP					
			12.					

NOT FOR CONSTRUCTION UNLESS LABELED AS CONSTRUCTION SET



SITE ID: LA SHREVEPORT


SHREVEPORT, LA 71104

SCALE:	1" = 5'
PROJECT:	907-2
DATE:	JANUARY, 2020
DRAWN BY:	DGJ
FILE NAME:	LANDSCAPE PLAN

SHEET TITLE LANDSCAPE PLAN

SHEET NUMBER

1/2

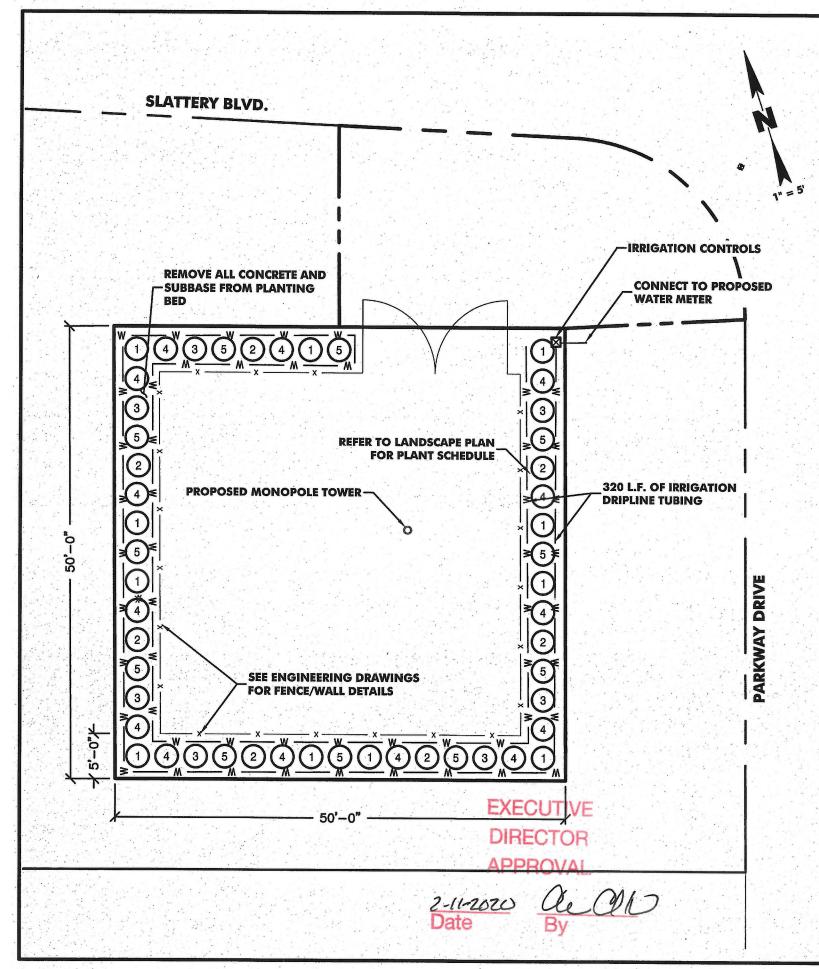

IRRIGATION SCHEDULE					
SYMBOL	TYPE	QTY	SIZE		
— w —	POLYETHYLENE MICRO DRIPLINE TUBING	320 L.F.	1/4" DIA.		
$\boxtimes$	IRRIGATION CONTROL	1	TBD		

# **GENERAL NOTES**

- ALL LANDSCAPED AREAS SHALL BE IRRIGATED WITH AN AUTOMATED IRRIGATION SYSTEM. THIS SYSTEM SHALL INCLUDE AN AUTOMATIC CONTROLLER. THIS SYSTEM SHALL BE INSTALLED ACCORDING TO ALL LOCAL GUIDELINES, CITY CODES, AND SHALL BE INSPECTED AND APPROVED BY THE APPROPRIATE AUTHORITIES.
- REMOVE ALL STONES AND DEBRIS FROM IRRIGATION TRENCHES PRIOR TO ANY BACKFILLING.
- ALL PVC PIPE JOINTS SHALL BE PRIMED WITH COLORED PRIMER PRIOR TO THE APPLICATION OF ANY GLUE.
- ALL CONTROL WIRING SHALL BE PLACED IN THE MAINLINE TRENCH ADJACENT TO THE MAINLINE PIPE. ALLOW FOR SOIL EXPANSION WITH 18" OF EXTRA WIRE COILED IN EACH VALVE BOX.
- IRRIGATION CONTRACTOR TO SIZE AND INSTALL IRRIGATION CONTROLS.
  COORDINATE THE LOCATION OF THE IRRIGATION CONTROLLER WITH THE OWNER OR OWNERS REPRESENTATIVE PRIOR TO INSTALLATION.
- ALL MATERIALS SHALL BE NEW AND UNUSED.
- ALL IRRIGATION DRIPLINES SHALL BE INSTALLED 2" BELOW GRADE, SECURED WITH MANUFACTURER RECOMMENDED STAPLES AT 36" O.C..
- DRIPLINE SHALL BE INSTALLED A MINIMUM OF 4" AWAY FROM EDGES OF HARDSCAPE ELEMENTS.
- 10. THE CONTRACTOR WILL SECURE ALL REQUIRED PERMITS AND PAY ALL ASSOCIATED FEES UNLESS OTHERWISE NOTED.
- 11. CONTRACTOR IS TO CONTACT APPROPRIATE AUTHORITIES AND LOCATE ALL UTILITIES PRIOR TO CONSTRUCTION. DAMAGE CAUSED BY THE CONTRACTOR TO ANY UTILITIES OR OTHER SITE WORK DURING THE INSTALLATION OF THE IRRIGATION SYSTEM SHALL BE REPAIRED BY THE CONTRACTOR AT THEIR OWN EXPENSE.
- 12. ANY EXISTING IRRIGATION ADJACENT TO NEW WORK LIMITS SHALL REMAIN IN OPERATION. THE CONTRACTOR SHALL NOTIFY THE OWNER'S REPRESENTATIVE OF ANY ADJUSTMENTS REQUIRED TO MAINTAIN OPERATION OF THE EXISTING SYSTEM DUE TO CONSTRUCTION WITHIN THE NEW WORK LIMITS.

# CAUTION NOTICE TO CONTRACTOR

THE CONTRACTOR IS SPECIFICALLY CAUTIONED THAT THE LOCATION AND/OR ELEVATION OF EXISTING UTILITIES AS SHOWN ON THESE PLANS ARE BASED ON RECORDS OF THE VARIOUS UTILITY COMPANIES AND, WHERE POSSIBLE, MEASUREMENTS TAKEN IN THE FIELD. THE INFORMATION IS NOT TO BE RELIED ON AS BEING EXACT OR COMPLETE. THE CONTRACTOR MUST CALL "LOUISIANA ONE CALL" BEFORE DIGGING - DIAL 811 OR 800-272-3020 AT LEAST 72 HOURS BEFORE ANY EXCAVATION TO REQUEST EXACT FIELD LOCATION OF UTILITIES. IT SHALL BE THE RESPONSIBILITY OF THE CONTRACTOR TO RELOCATE ALL EXISTING UTILITIES WHICH CONFLICT WITH THE PROPOSED IMPROVEMENTS SHOWN ON THE



Alta Towers, LLC

## RILEY COMPANY **ENGINEERS & SURVEYORS**

P.O. DRAWER 1303 ELEPHONE (318) 251-0238

RUSTON, LA 71273-130 FAX: (318) 251-0239

REVISIONS					
REV	INITIALS				
1 12/02/20		CONSTRUCTION DOCUMENTS	HRP		
8	4.5				
			W.		

NOT FOR CONSTRUCTION UNLESS LABELED AS CONSTRUCTION SET



SITE ID: LA SHREVEPORT

SHREVEPORT, LA 71104

					and the same		
SCALE:				4.5	1"	-	5'
PROJECT:					: 8	07	-2
DATE:	5 -		JAN	UAF	₹Y,	20	20
DRAWN BY:		,				D	G
FILE NAME:		1	LANDS	SCA	PE	PL	AN
		_	-			-	

SHEET TITLE IRRIGATION PLAN

SHEET NUMBER